BASIS OF DESIGN | DRAWINGS | RENDERINGS



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JAN 18, 2021

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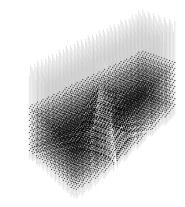


JAN 1**8**, 2021

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Conne




In 1881 San Jose was pioneer designing "The Electric Light Tower" (SJELT). The shape of the SJELT inspires a pyramidal void based on the 75-foot x 200-feet dimensions of the original SJELT to celebrate this unique moment in San José's history in the collective memory.

SJELT comes to life inside the new Tower like a void of light

BASIS OF DESIGN I . DESIGN NARRATIVE Part 2. An Icon for Silicon Valley

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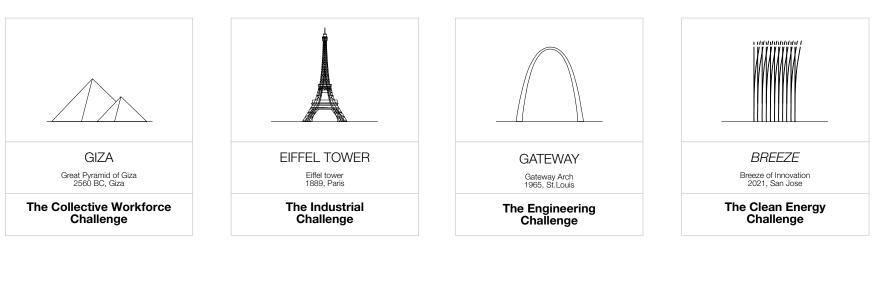
If the connection to San Jose is at the heart of the project, the connection to Silicon Valley is in its envelope, formed by hundreds of rods that generate responsive energy when moving in the wind. An environmental statement, in which clean energy harvesting materializes in a gesture creating a choreography of light, shadows, human movements, experiences and emotions.

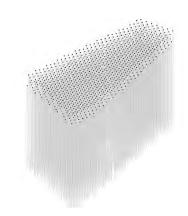A LANDMARK FOR THE FUTURE **Connecting with the Planet**



The Icon

The new landmark in San Jose materializes in a gesture, a white brush stroke in the blue sky of San Jose, formed by hundreds of rods that generate responsive energy when moving in the wind*. An environmental statement, in which clean energy harvesting materializes in a gesture.





A LANDMARK FOR THE FUTURE **Connecting with the Planet**

Throughout history, the megastructures that have transcended their time and have become **global icons** are those that were pioneers in response to the challenges of their time.

The challenges facing the world in the 21st century are many, but if there is one that, due to its relevance, acquires an importance that affects the entire planet, it is climate change and the need to shift the way we generate energy, in search of cleaner energy sources. This project does not intend to solve climate change, but we believe that large public projects could serve to send a message; a world with clean energy is entirely possible.

This project does not pretend to invent a new technology, its purpose is to create awareness and send a positive message to future generations, that a clean planet is possible... The goal is to make the energy harvesting obvious and visible, in order to trigger, to change perception, to question reality... to inspire. Thanks to a very simple technical system*, the tip of the rods will light up only when it is windy. In this way, people could directly perceive that it is the wind that creates the lighting, at no cost.

Stage 1 Competition Location

New location. An Adaptable Structure

The footprint of the tower is generated from the existing park pathways and the construction boundaries allowed. It is placed in the most visible area for visitors coming from the CBD or the Siridon Train Station, generating a public Plaza in front of the SAP Arena on the corner between N Autumn St and Santa Clara St.

Following the SAP requirement and in light of the new Google's master plan that includes several high-rise buildings in the vicinity of the initial location, the project is located north of Autumn St. Thanks to the flexibility of the project plan, it adapts to the new location, generating interesting possibilities for activating the park.

(*) As requested by the SAP Centre during Stage 2, the project has been moved to a new location inside the construction boundaries

A LANDMARK FOR THE URBAN CONFLUENCE Connecting with the River




What if the new landmark is the beginning of something much bigger?

Can you imagine a walk through the whole river? A walk that not only recovers the river for the park but for the city. A walk that links and recovers the memory of Guadalupe River for pedestrians and bikers.

A LANDMARK FOR THE URBAN CONFLUENCE Connecting with the River

The new location will benefit from the sunset light, as it is not blocked by the SAP center and establishes a more direct connection with the confluence of the Guadalupe River and Los Gatos Creek.

We understand that the project is an opportunity to create a real walkway along the river. A pedestrian and bicycle pathway that connects green spaces along the river.

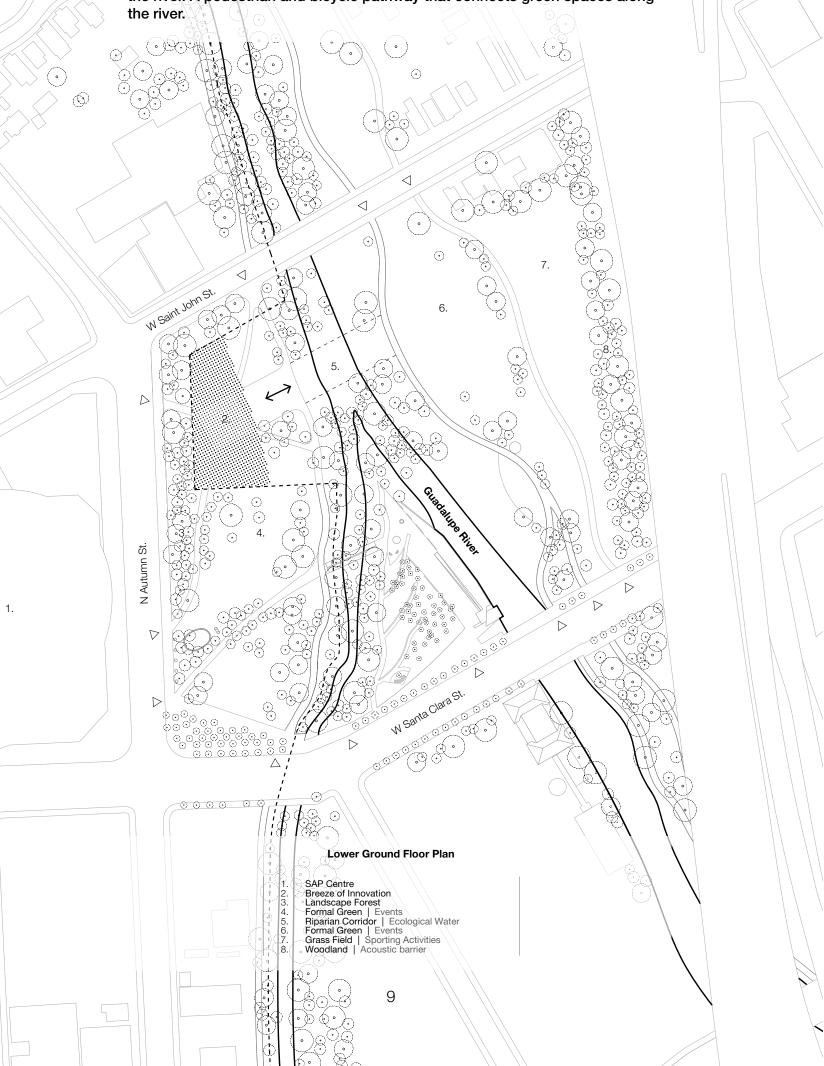

A LANDMARK FOR THE URBAN CONFLUENCE **Connecting with the Arena East**



The Bridge

Visualization showing the possible connection of the project with Arena East through a bridge. (* The bridge is not part of the main proposal, it is just an idea to the choice of the City of San Jose)

What if the new landmark is the beginning of bigger?

Footprint

The building's footprint to the West.

Landscape Plaza


To recover the river for the park and activate a comfortable area full of possibilities, a landscaped plaza is proposed in front of the building.


A LANDMARK FOR THE URBAN CONFLUENCE **Connecting with the Arena East**


something much


A walk that links and recovers the memory of Guadalupe River for pedestrians and bikers.

starts from River Setbacks to the East, W Saint John St to the North, and Autumn St

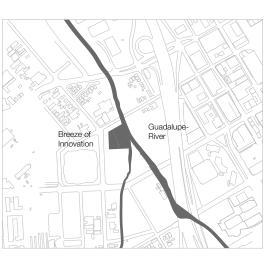

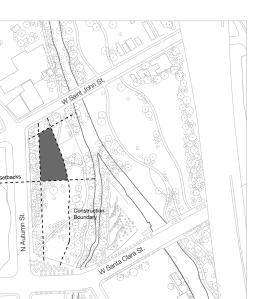

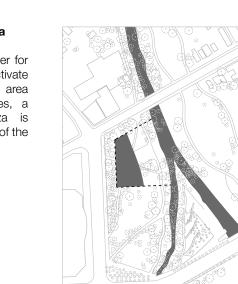

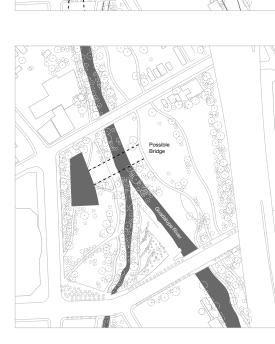

A green space connector

Columbus Park Guadalup River Park Arena Green John P. McEnery Park Discovery Meadow

Bands

The landscape strategy contemplates a series of bands that are diluted, recovering the memory of the park: the forest, and the river. The proposed structure is related to all of them.

- SAP Centre Breeze of Innovation Landscape Forest Formal Green
- Events Riparian Corridor 5.
- Ecological Water Formal Green 6.
- Events Grass Field Sporting Activities Woodland 7.
- 8. Acoustic barrier

Bridge

A potential bridge will solve the current disconnection between Arena Green West and East*.


(*) This bridge is just an idea to the choice of the City of The project works, both with the topographical park and with the bridge.

To enhance the connection with the river, the project gently modifies the topography to generate a plaza to the East, which can be activated in different ways for outdoor cafe, events, concerts, exhibitions.

One possibility to develop this idea in the future * would be to continue this plaza with a bridge (designed with a permeable structure, so that the riverside vegetation can continue to grow) This Bridge will solve the current disconnection between Arena Green West and East.


PARK ACTIVATION Connecting with the River

To recover the river for the park and activate a comfortable area full of possibilities, a landscaped plaza is proposed in front of the building. To enhance the connection with the river, the project gently modifies the topography to generate a plaza to the East, which can be activated in different ways for outdoor cafe, events, concerts, exhibitions.

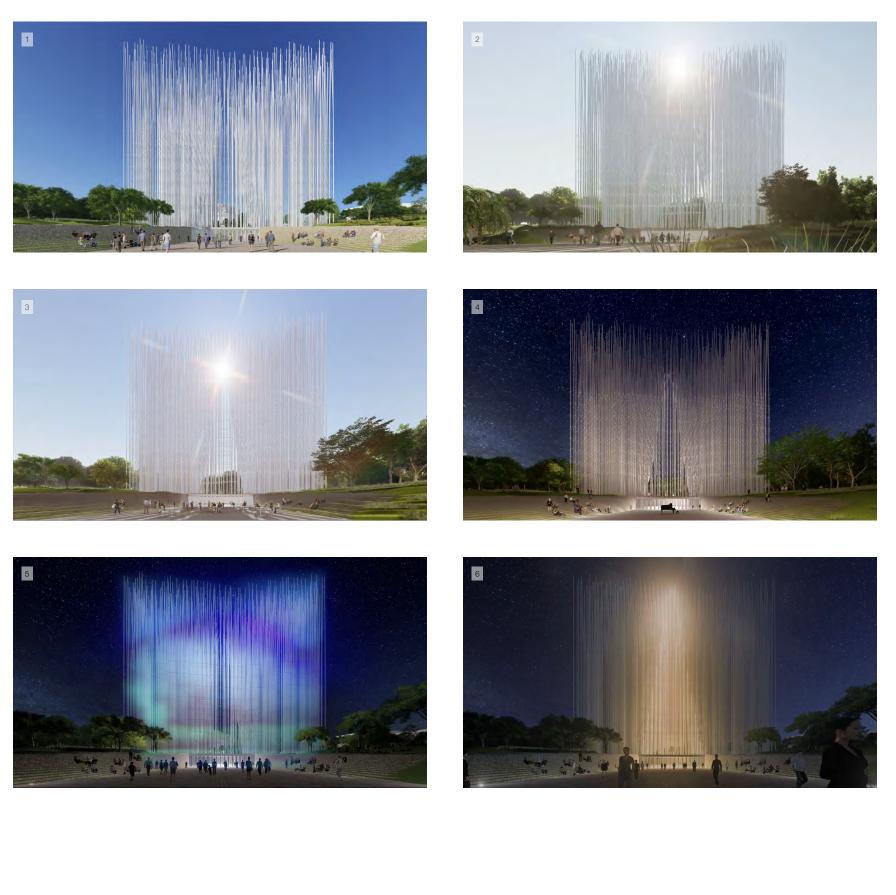

Connecting Device
 Performances | Outdoor Night Events
 Void Performance Space

PARK ACTIVATION Connecting with the River

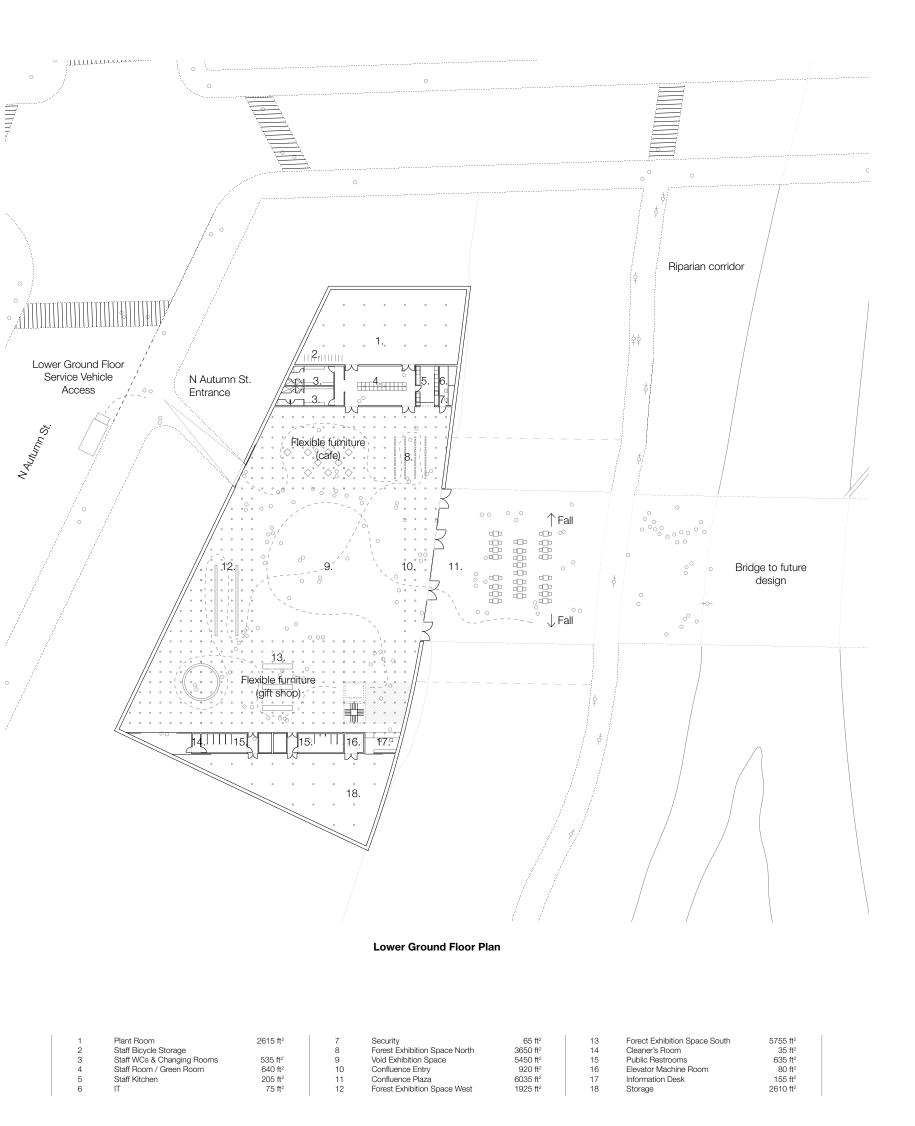


A LANDMARK FOR ARENA GREEN Connecting with the Park



The Park

The intention is that the project, on the one hand, becomes a Landmark that serves as a reference and activates the space that surrounds it and, on the other hand, it dissolves in the park connecting with the paths that converge in the central space, which will host events and exhibitions.

A LANDMARK FOR ARENA GREEN Connecting with the Park

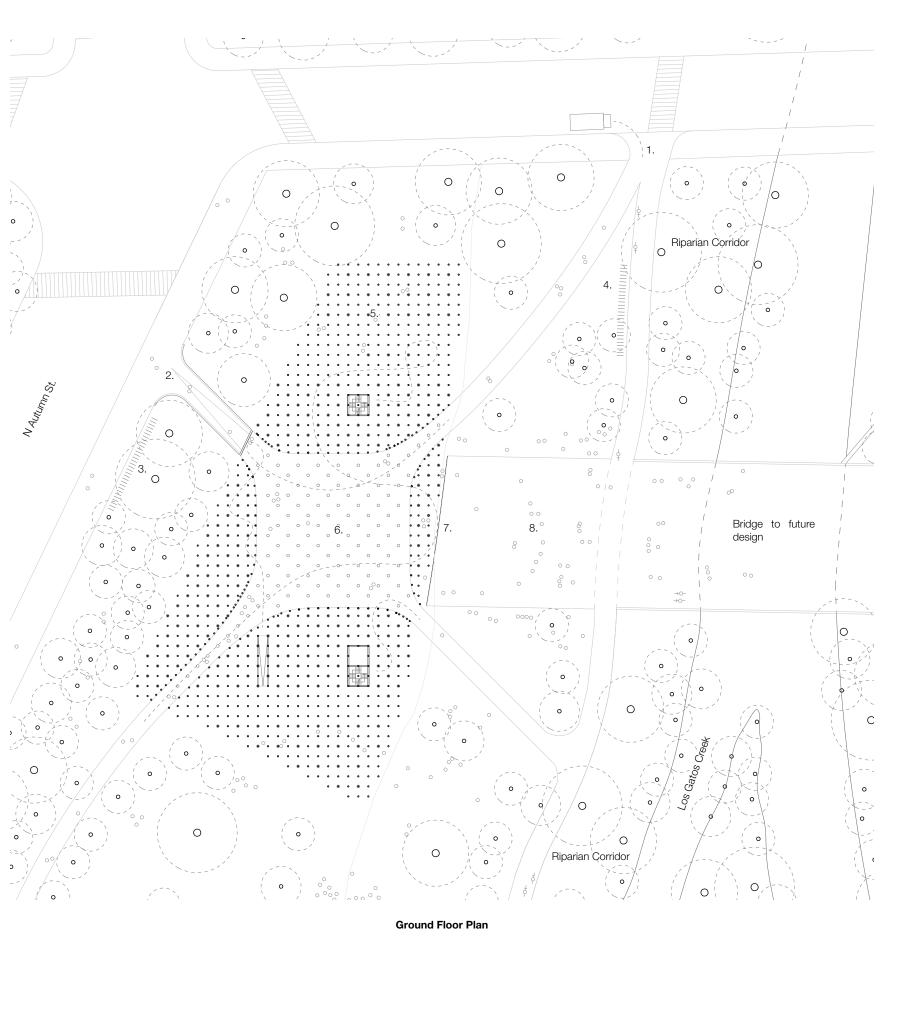

 Ground Floor Service Vehicle Access North Autumn Street Entrance Bicycle Parking Bicycle Parking 	5 6 7 8	Forest of Light Exhibition Space Tower of Light Exhibition Space Confluence Entrance Plaza & Connection to Future Bridge	18577 ft ² 5700 ft ²
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EXPERIENCING THE WALKWAY **Connecting with the Valley**



The Walkway

Visitors can experience the walkway ride in a number of ways, leisurely or jogging, while taking in views of the valley on their way to the top.

(*) In case it is necessary for social distancing)

EXPERIENCING THE WALKWAY Connecting with the Valley



Observatory Deck Floor Plan

0

prest of Light Exhibition Space wer of Light Exhibition Space

onfluence Entrance

A LANDMARK FOR SAN JOSE Connecting with the City




A landmark for the City

Breeze is visible from all angles of the city, where you can see the spectacle of watching visitors walking the ramps to the top.

A LANDMARK FOR SAN JOSE Connecting with the City

In 1881 San Jose pioneered design with "The Electric Light Tower" (SJELT), the first technological Icon of the World that later inspired the Eiffel Tower, built in 1889.

The large central space has the same dimensions as the original tower, celebrating its rebirth as a space of light.

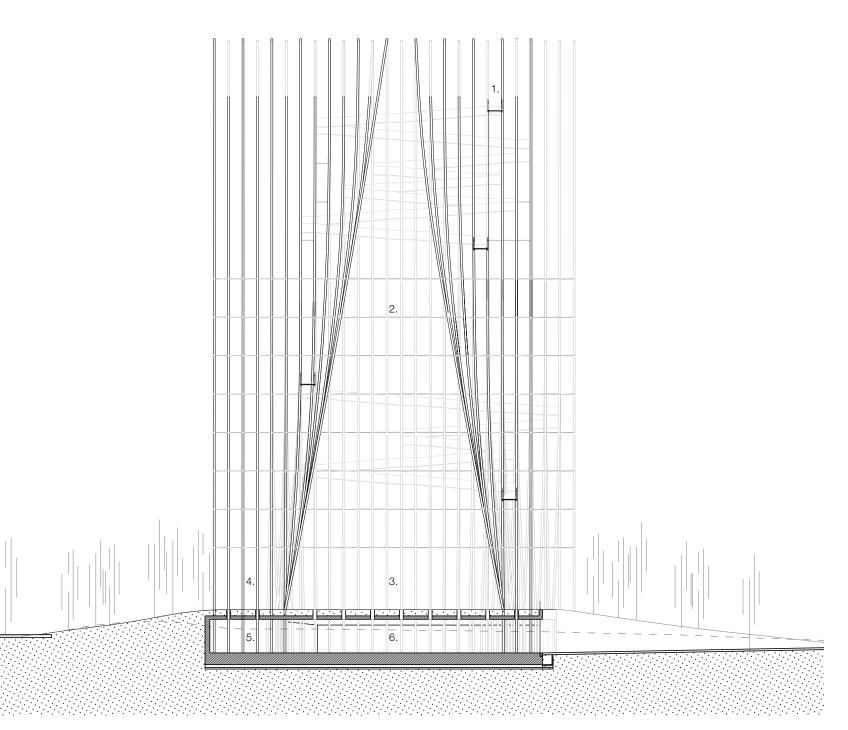

Long Section

4

5

6

1 Walk 2 Void 3 Tow

Walkway Void Tower of Light Exhibition Space Forest of Light Exhibition Space Donor Recognition Space Void Exhibition Space

A DAYLIGHT LANDMARK Connecting with the Environment

The objective of the project is twofold, on the one hand the tower aims to generate unique experiences at night, thanks to the lighting systems developed, but on the other hand, and because experience tells us that these types of structures are more enjoyed during the day, we have tried to develop a new and fresh silhouette, that sways in the breeze, that works as an important attraction during the day.



4 **East Elevation** Night | No Wind


South Elevation


Late Evening Sun | Southwest Wind

3


A DAYLIGHT LANDMARK Connecting with the Environment

After an analysis of the influx of visitors to the most iconic structures in the world, the data tells us that they receive 90% of the visitors during the day. The project design is intended to take full advantage of the changing light and the soundscape that is produced when the rods move in the breeze.

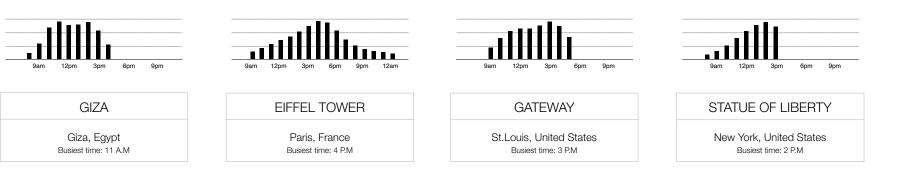

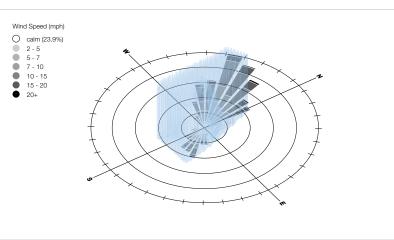


Wind

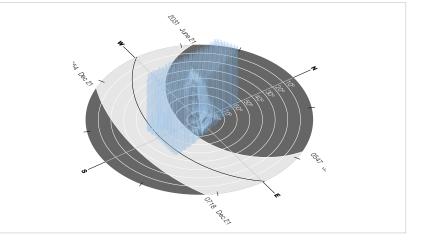

Sun

Breeze enjoys the prevailing northwest wind, its structural design allows controlling the deflection of the rods, enough so that it is perceived as they swing gently with the wind.

The design of Breeze, its orientation and the density of the rods, is thought, in addition to obtaining an optimal light structure, to generate light and shadow effects during the day.

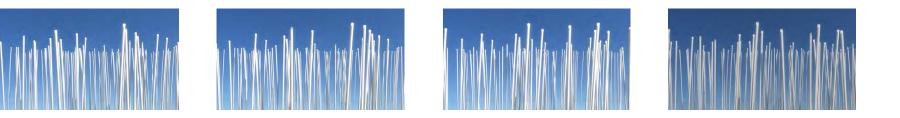


The Rods


The Breeze of Innovation structure is intended to flex slightly in the wind, creating a dramatic visual effect for visitors to experience and enjoy. The movement of the vertical pipe structure is controlled by biasing the shape and orientation of the pipes of the structure to intentionally control their movement.

MERGING WITH CONTEXT Connecting with the Environment

The project design is intended to take full advantage of the changing light and its materiality reflects the colors of the environment.

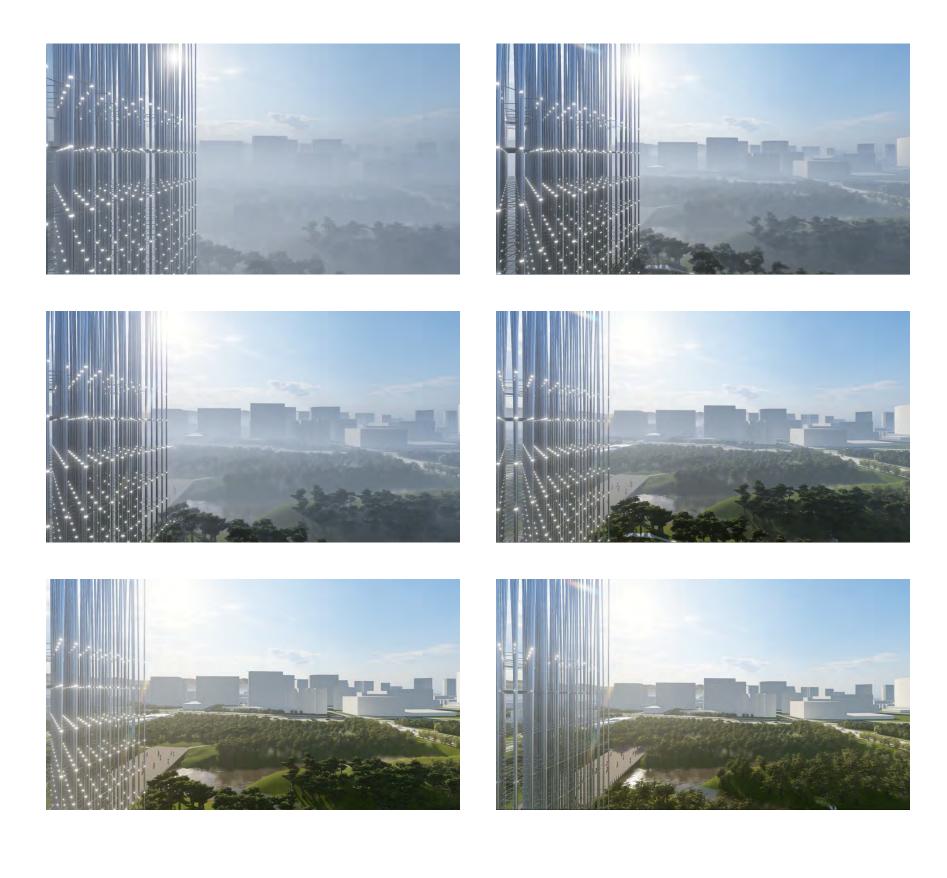

MERGING WITH CONTEXT Connecting with the Environment

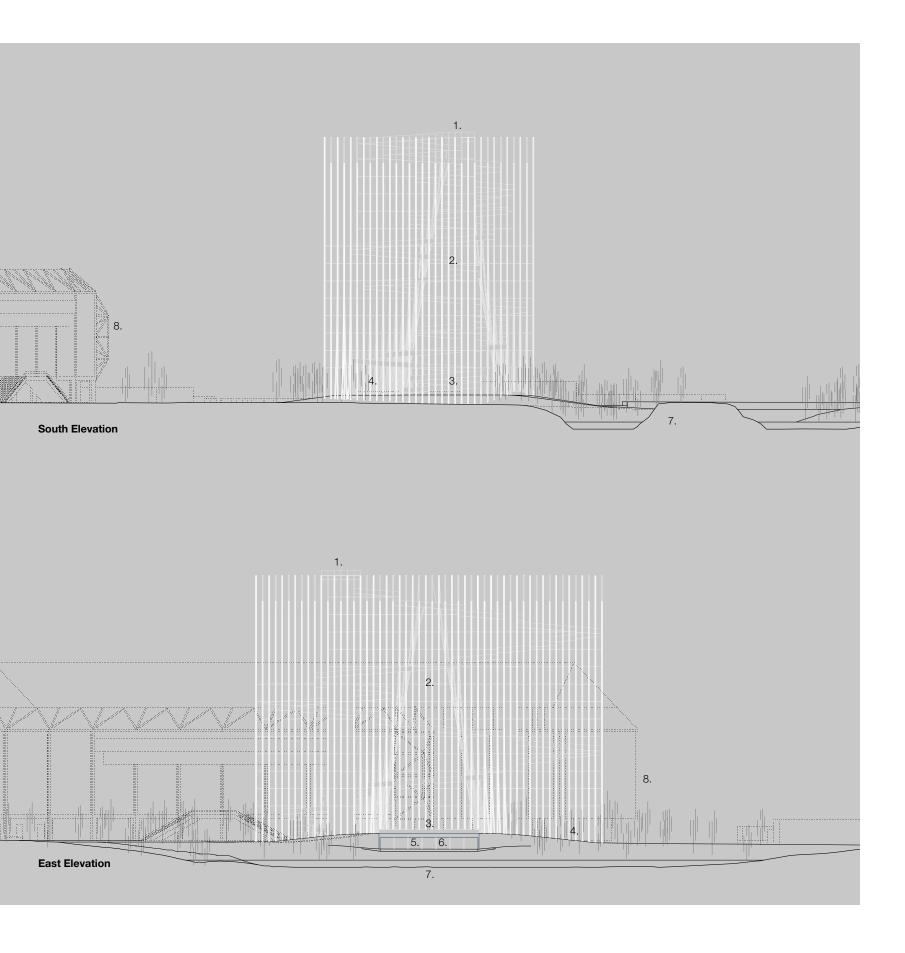

1	Viewing platform
2	Void
3	Tower of Light Exhibit


ibition Space 4 Forest of Light Exhibition Space Donor Recognition Space Void Exhibition Space Guadalup River SAP Arena

5 6

8

A LANDMARK FOR THE CITY Connecting with the Neighborhood


Breeze's fresh and iconic presence is visible from every angle when you approach San Jose. The light density of the rods, the swaying of the wind, and the void inside as a tribute to the original Electric Light Tower make Breeze, an iconic and recognizable silhouette when one approaches San José.

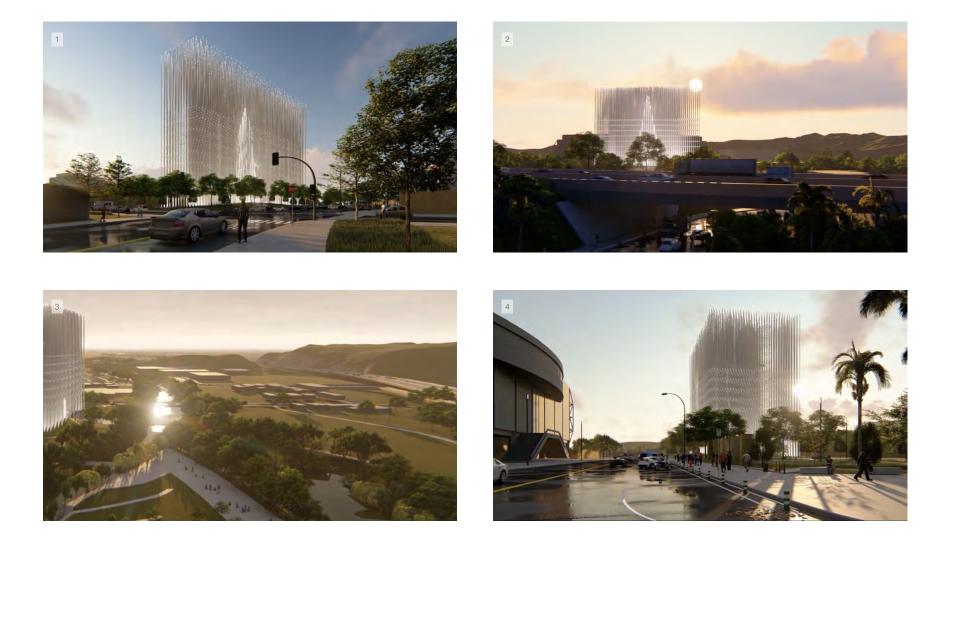

1 View from N Autumn St 2 View from San Jose CBD

3 Aerial View 4 View from W Santa Clara St

A LANDMARK FOR THE CITY Connecting with the Neighborhood

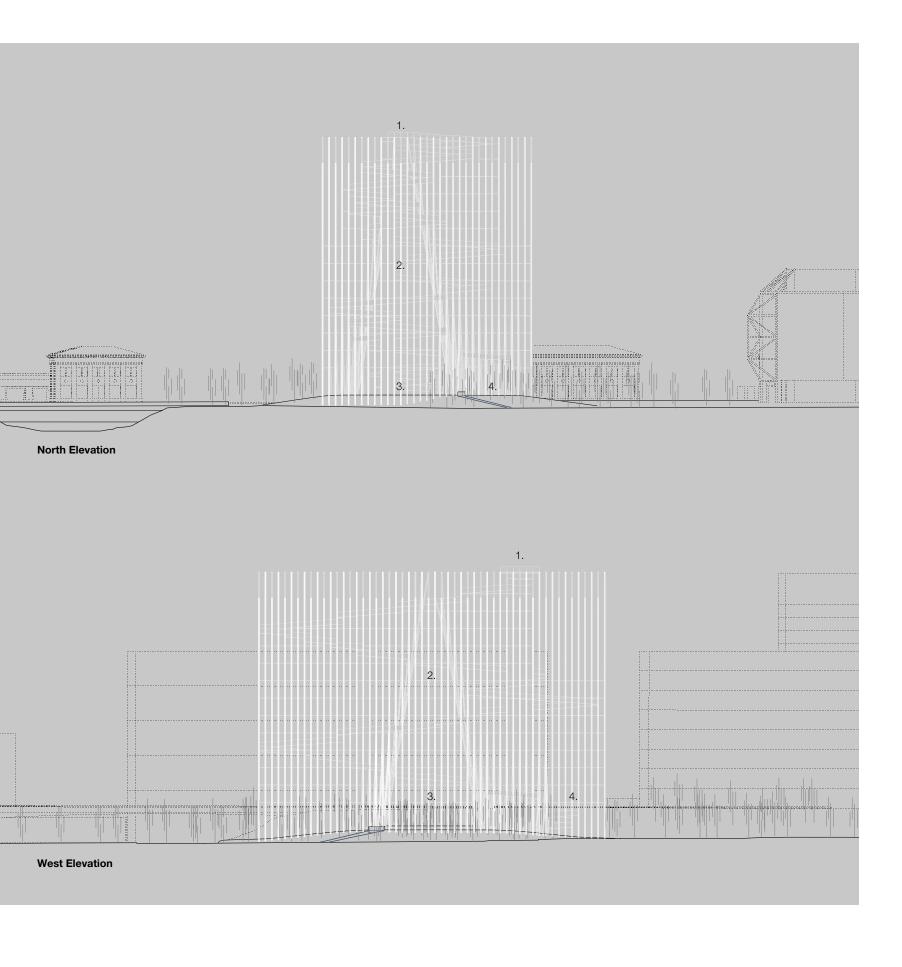


1 Viewing platform 2

Void

4

3 Tower of Light Exhibition Space Forest of Light Exhibition Space

A TRIBUTE TO SJELT Connecting with Memory

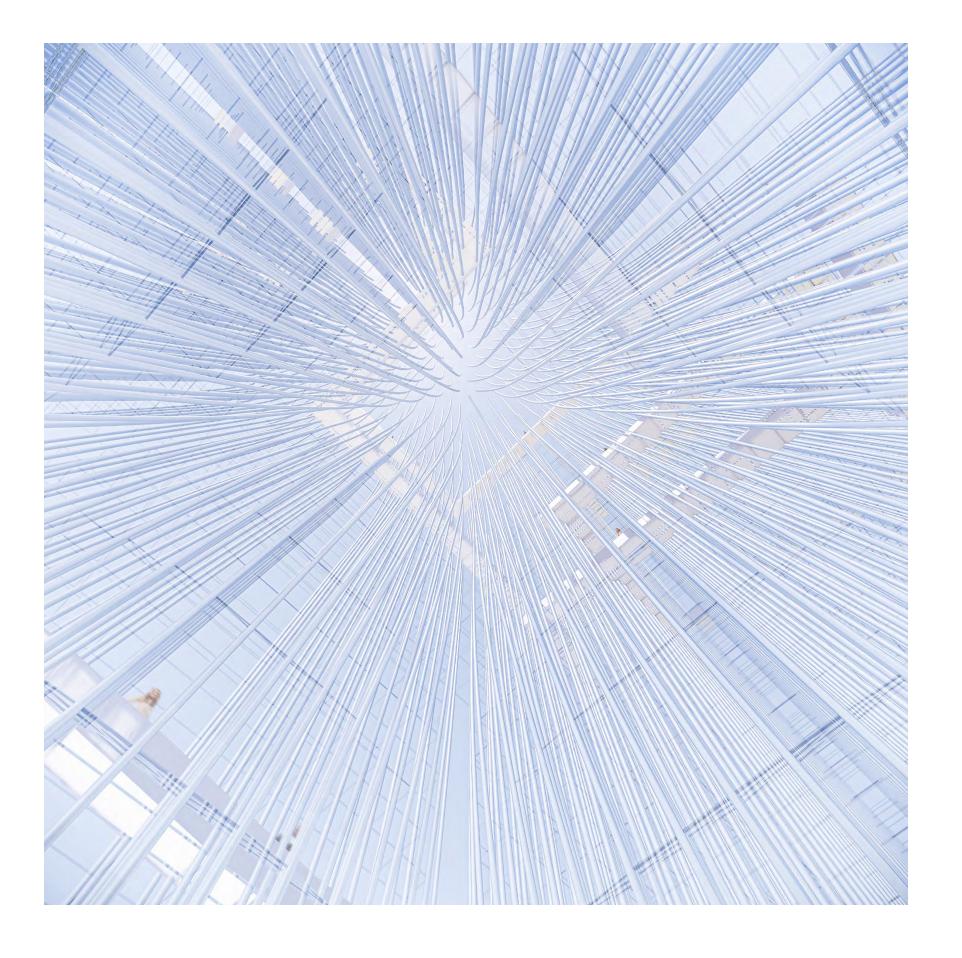


The Void

View towards the interior of the light tower from the large central space.

A TRIBUTE TO SJELT Connecting with Memory

In 1881 San Jose pioneered design with "The Electric Light Tower" (SJELT), the first technological Icon of the World that later inspired the Eiffel Tower, built in 1889. The shape of the SJELT inspires a pyramidal void based on the 75 x 200 foot dimensions of the original SJELT, to celebrate this unique moment in San José's history in the collective memory.

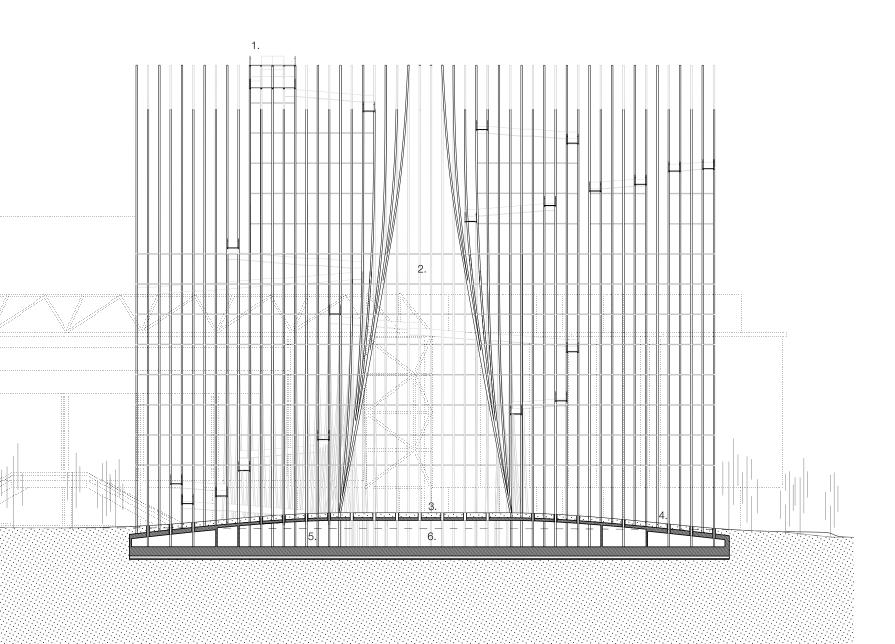

Long Section

4 5

6

1	Viewing platform	
2	Void	
3	Tower of Light Exhibition Space	
	1	

Forest of Light Exhibition Space Donor Recognition Space Void Exhibition Space

THE EXPERIENCE

Connecting with 5 Senses


The fact that the rods have a subtle flexibility in their upper part and sway with the wind, makes the experience involve the 5 senses, perceiving the sounds of the breeze and the rods swaying.



Breeze offers a journey of discovery as the tower is traversed from the bottom up, the foundations are unveiled to reveal galleries full of possibilities, the large central space, the walkways, which offer different views of the valley and the spectacular landscape of light when it reaches the top.

- 1|2 3|4 Observatory Deck Experience Ramp Experience 5 6
 - Donor's Gallery Experience
 - Ground Floor Experience

THE EXPERIENCE **Connecting with 5 Senses**

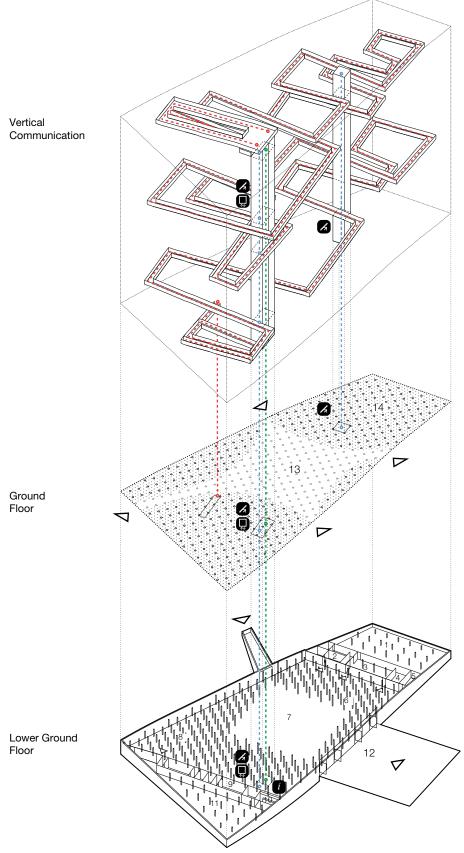

Axonometric

 Storage Staff facilities Staff break-out / green room Staff kitchenette IT & Security 	6 7 8 9 10	Indoor cafe Void Exhibition space Donor Recognition Space Public facilities Front desk / information	11 12 13 14	Storage Outdoor cafe Tower of Light Exhibition Space Forest of Light Exhibition Space
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TOWER OF LIGHT Connecting with San Jose




Interior view of the central light space as a tribute to SJELT.




The San Jose Electric Light Tower **(SJELT) comes to life inside the new Tower just like a void of light.** Like the Eiffel Tower, SJELT represented the construction techniques of the second industrial revolution.

The question is, would it make sense to embed the old SJELT structure into the new one, given 21st century technology, particularly in Silicon Valley is characterised by digital technologies being invisible.


What better way to celebrate the rebirth of the old Light Tower than as a space of light?

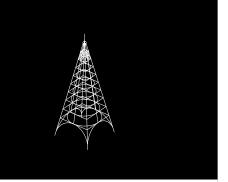

2nd Industrial Revolution Material Past

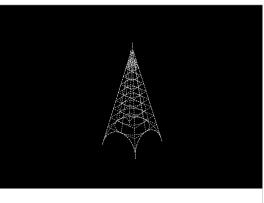

Dematerialization

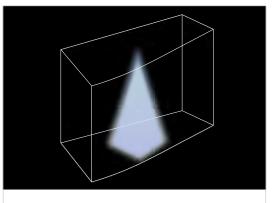

5th Industrial Revolution Immaterial Future











Views of the dematerialization of the central light space at different times of the day.

AN INMERSIVE EXPERIENCE Connecting with each other



Interior view of the central light space illuminated with a 3000K warm light.

It's important to tackle negative emotional climates with strategies to reconnect communities in a positive way. We didn't want to design an experience that could be achieved through VR, but an intimate space that enhances the physical connection with others through light. For this, we have designed the central space of Breeze of Innovation, to generate an experience that during the day enjoys the light effects between the rods as light changes and in the evening, it can be illuminated according to circadian rhythms.









AN INMERSIVE EXPERIENCE

Connecting with each other

COVID-19 has forced us into social distancing, isolation and quarantine. These conditions are likely fostering widespread anxiety and loneliness in our cities. However, they've also made the need for socially connected, vibrant public spaces obvious to all. After 2020 if one thing has become clear is that we can connect digitally, but we are alone if we don't connect physically with others, with our community.

6000 K	5000 K	4000 K	3500 K	3000 K	2850 K	2200 K
pendable	Unique	Soothing	Optimism	Warm	Friendly	Cheerful

Exterior views of the central light space with different color temperatures.

DONOR'S GALLERIES Connecting with the Roots




Donr's Gallery

We found it interesting to reflect the experience of the tower downwards, making the foundation space habitable. If the rods, visible from the outside, represent the companies and people who work in Silicon Valley, what better place to pay tribute to those who with their efforts make this structure possible, than the foundations on which the building is supported.

DONOR'S GALLERIES Connecting with the Roots

We found it interesting to reflect the experience of the tower downwards, making the foundation space habitable. If the rods, visible from the outside, represent the companies and people who work in Silicon Valley, what better place to pay tribute to those who with their efforts make this structure possible, than the foundations on which the building is supported.

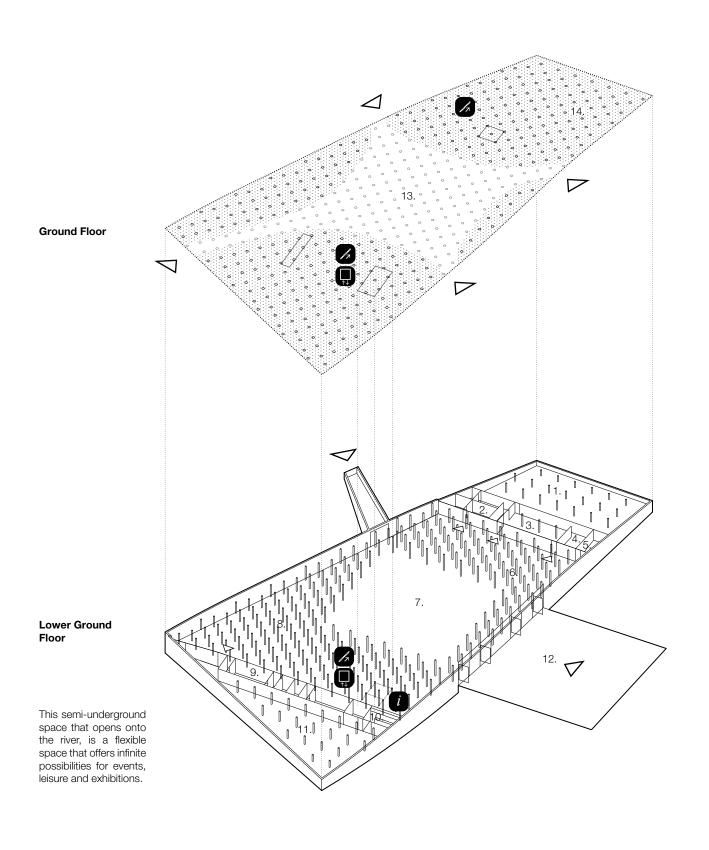

Axonometric

Storage Staff facilities

IT & Security

Staff kitchenette

Staff break-out / green room

1 2 3

4

5

6	Indoor cafe	11
7	Void Exhibition space	12
8	Donor Recognition Space	13
9	Public facilities	14
10	Front desk / information	

Storage Outdoor cafe Tower of Light Exhibition Space


Forest of Light Exhibition Space

MAGIC WANDS **Connecting with Silicon Valley**




Connection


From the beginning, Silicon Valley amazes the world every day by creating technologies so advanced that, in the words of Arthur Clarke, they are indistinguishable from magic.

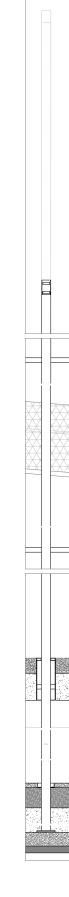

MAGIC WANDS **Connecting with Silicon Valley**

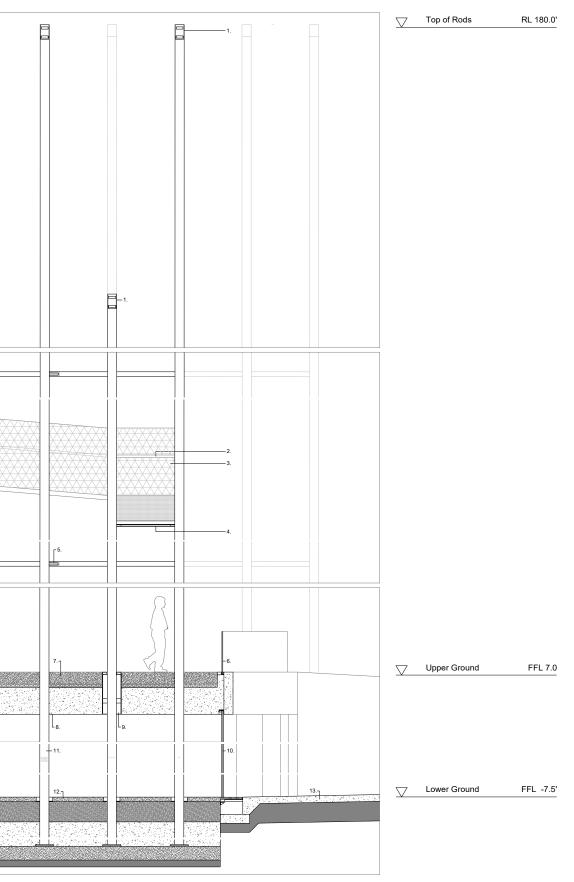

The movement of the vertical pipe structure is controlled by biasing the shape and orientation of the pipes of the structure to intentionally control their movement.

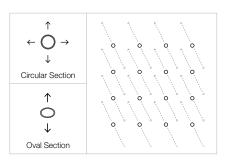

By alternating the lengths of the pipes, visual effects of motion are maximized without adjacent pipes colliding.

- 1. Energy generating responive lighting tips
- 2. Continuous stainless steel handrail fixed to balustrade substructure at 2'10" via concealed connection
- 3. Woven stainless steel mesh balustrade to 5' above floor surface
- 4. Non-slip surface and proprietary energy generating paving system on 2" SPS floor system with, fixed on site via concealed bolted connection to stub welded to vertical rod
- 5. 4" stainless steel bracing tube welded to vertical rod. Connects to adjacent rod assemblys via threaded connection on site
- 6. Structural low-iron glass handrail
- 7. 10" Crushed white gravel, on geotextile membrane, on 4" structural drainage layer, on waterproof membrane
- 8. Concrete soffit
- 9. 16" diameter tubular skylight around stainless steel rod
- 10. Low-iron glass facade
- 11. Stainless steel rod, satin finish, with engraved donor names
- 12. 4" Polished concrete screed, over 18" gravel, over 4' concrete raft slab, over 12" setting out slab
- 13. 6" Slab on grade on 18" engineered fill

Constructive Section

The Breeze of Innovation structure is intended to flex slightly in the wind, creating a dramatic visual effect for visitors to experience and enjoy. The movement of the vertical pipe structure is controlled by biasing the shape and orientation of the pipes of the structure to intentionally control their movement.

MAGIC WANDS Responsive Energy




Observation Deck

View of the upper part of Breeze of Innovation, with the observation deck, above the rods illuminated by the wind.

MAGIC WANDS


Responsive Energy

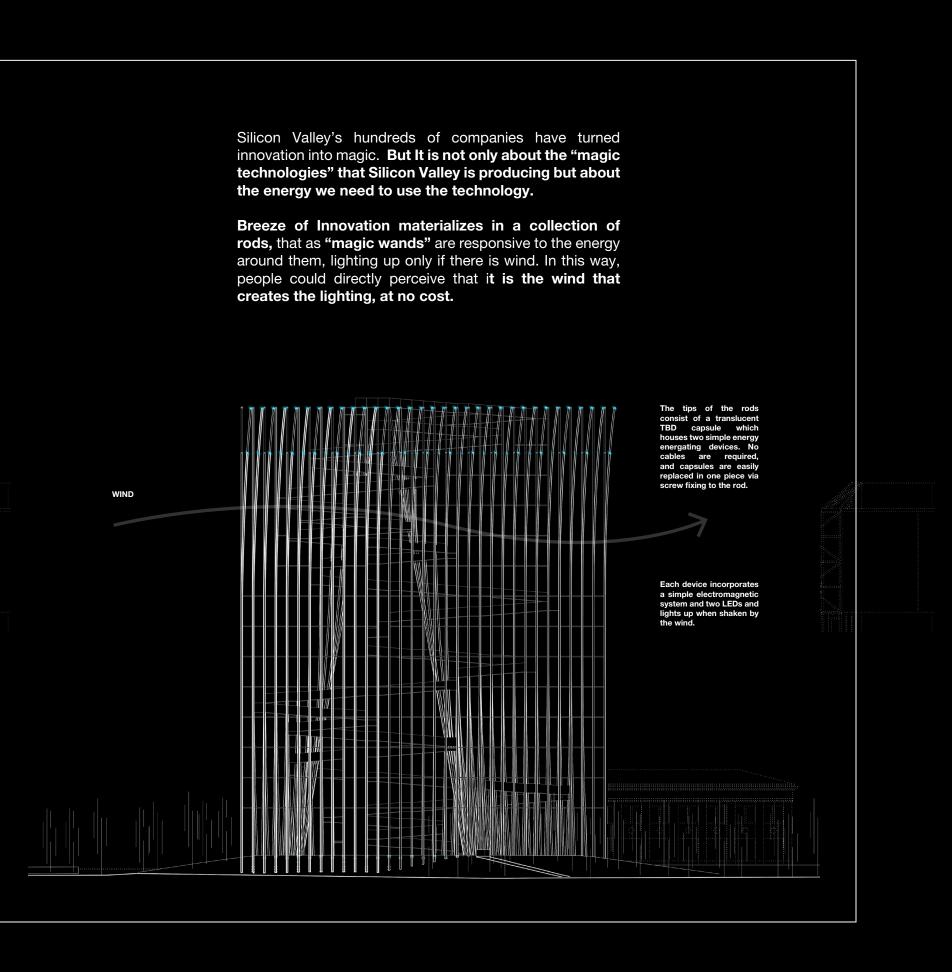

Night Elevation


East elevation, where we can perceive the smooth movement of the rods with the wind.

THE EVER CHANGING MAGIC OF SILICON VALLEY Power of People

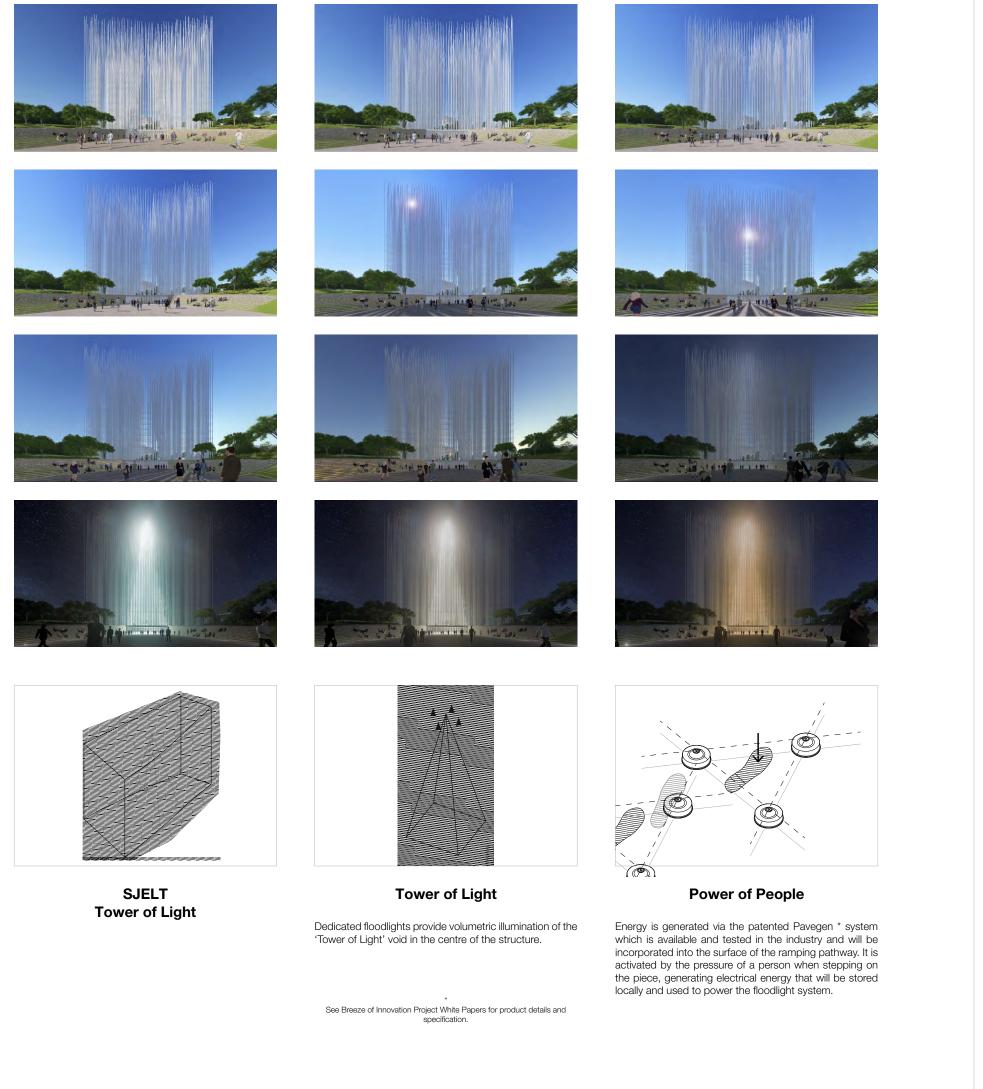

40


THE EVER CHANGING MAGIC OF SILICON VALLEY Power of People

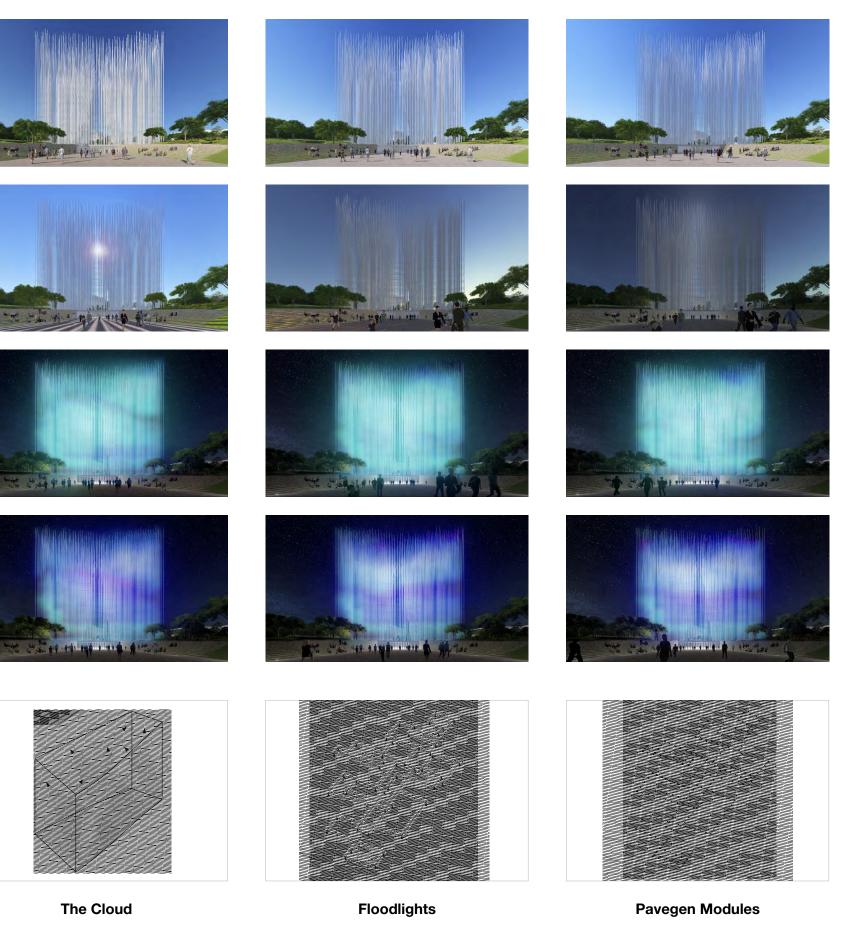

Strategically located floodlights provide adaptive and granular illumination to the entire interior of the structure.

* See Breeze of Innovation Project White Papers for product details and specification. Pavegen electricity generating modules are integrated throughout the pathways. The energy generation, storage and lighting systems are all integrated into the ramp structure facilitating easy maintenance and upkeep.


THE EVER CHANGING MAGIC OF SILICON VALLEY Power of Wind

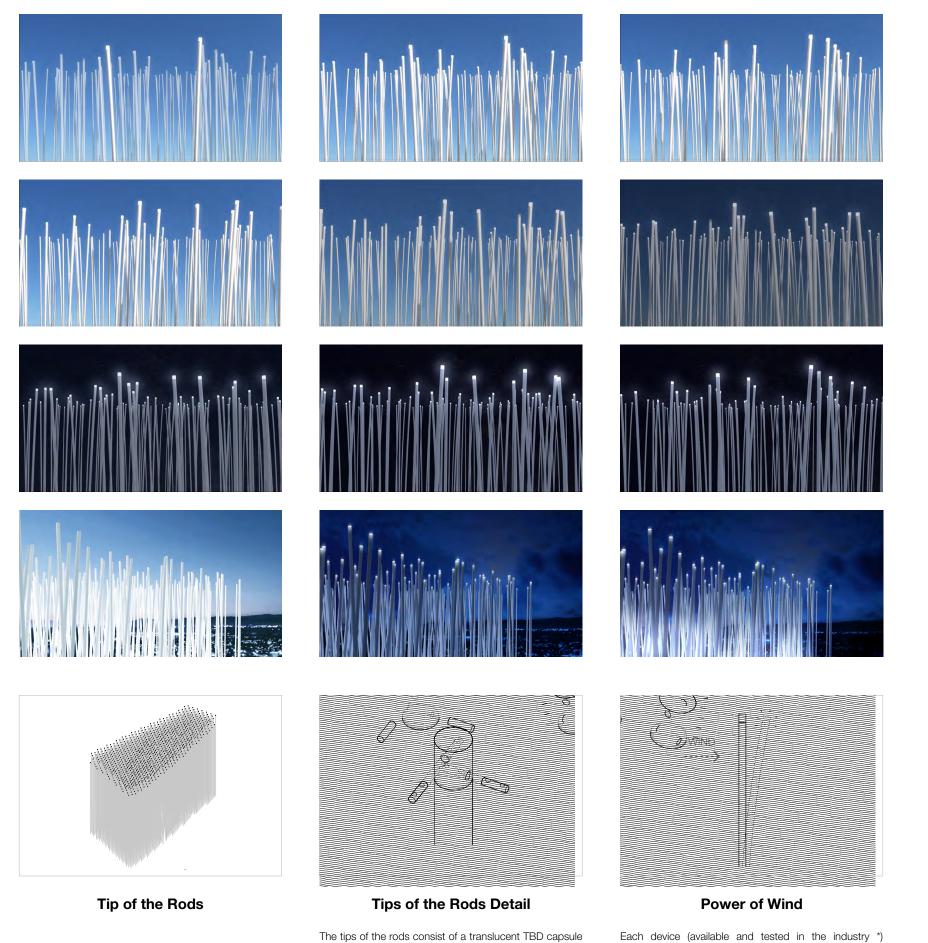

Each device (available and tested in the industry *) incorporates a simple electromagnetic system and two which houses two simple energy energating devices. No cables are required, and capsules are easily replaced in one piece via screw fixing to the rod. LEDs and lights up when shaken by the wind.

See Breeze of Innovation Project White Papers for product details and specification.

THE EVER CHANGING MAGIC OF SILICON VALLEY **Connecting with the Planet**

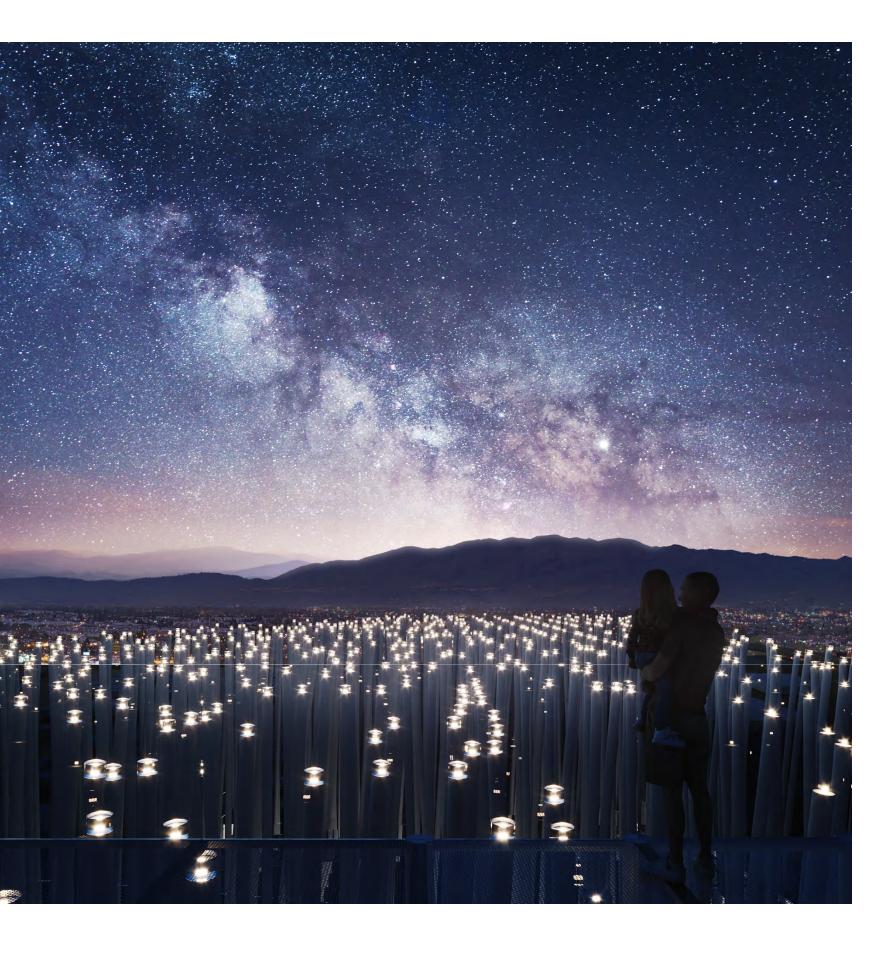

Observation Platform at Night

The core purpose of the project is to create awareness and send a positive message to future generations, that a clean planet is possible ... The goal is to make clean energy obvious and visible, in order to trigger, to change perception, to question reality... to inspire.

And what better way to inspire than to create an unforgettable experience?


BREEZE OF INNOVATION PARK ACTIVATION



JAN 18, 2021

BASIS OF DESIGN II . PARK ACTIVATION

ARENA GREEN ACTIVATION	P48
LITHOSPHERE	P52
BIOSPHERE	P56
ATMOSPHERE	P60
ANTHROPOSPHERE	P64

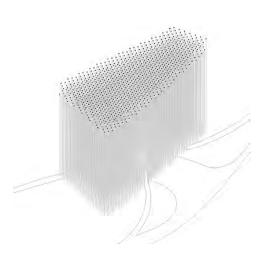

A Landmark that serves as a reference and activates the space that surrounds it. It dissolves in the park connecting with the paths that converge in the central space, which will host events and exhibitions.

BREEZE OF INNOVATION Arena Green Activation



Stage 01 Location

Following consultation and feedback from take holders in stage 02, we decided to re-locate the project to an area we explored early in the design process of stage 01 in the north-western area of Arena Green.

1. Connection to the SAP Arena without competing for attention

BREEZE OF INNOVATION Arena Green Activation




2.

Room to breathe and therefore high quality viewing opportunities from many angles **3.** Varied scale of urban interfaces 4.

Opportunities for stronger public connection to the Guadalupe River and riparian corridors 5.

Strong presence and dialogue with the Eastern Lawn of Arena Green

BREEZE OF INNOVATION Arena Green Activation

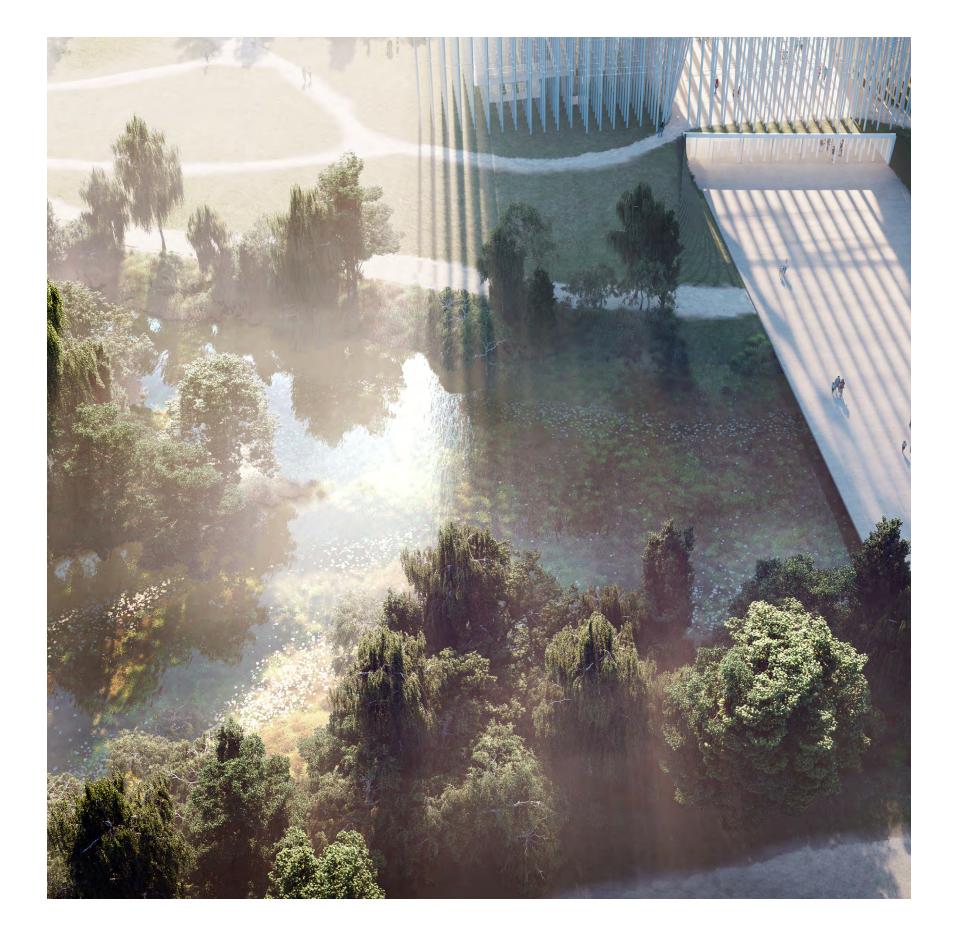


The Experiences

Through the Breeze of innovation project, we hope people will gain a greater awareness of the forces of nature that run through San Jose and our human-made environments, and build a deeper appreciation of how intimately interconnected are human and natural systems.





BREEZE OF INNOVATION Arena Green Activation

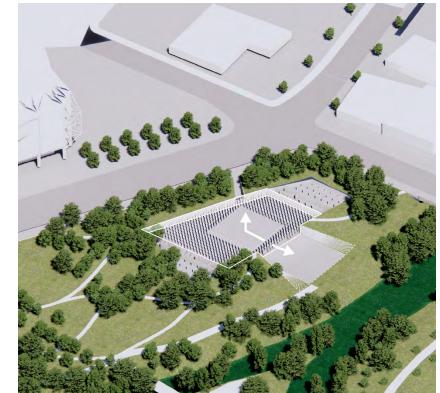

Lithosphere



Biosphere



Atmosphere



Anthroposphere

Through the experiences of the project, visitors will be able to see, hear and feel the energy and significance of natural systems flowing through our human-made environments - a world we are continually creating.


BREEZE OF INNOVATION Lithosphere



Foundation Event Space

This space is the functional heart of Breeze on Innovation containing all of the spaces which support it's operation and maintenance. It is also a space where indoor events can be held, and where visitors can feel the Earth beneath the structure.

BREEZE OF INNOVATION Lithosphere

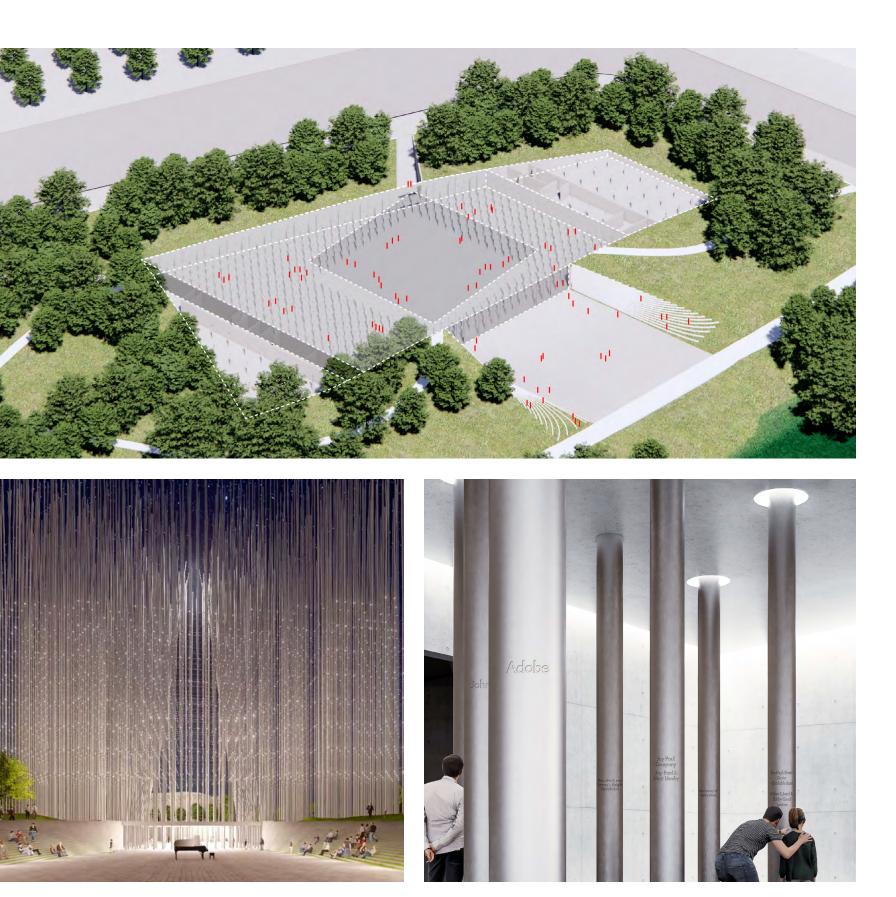

Confluence Plaza

Foundation Event Space

Donor Recognition


The stainless steel rods of the structure which symbolize the collective effort & endeavour of the people and companies of Silicon Valley, will also recognize the people who are making the Urban Confluence endeavour possible. In the foundation event space, the names of all donors to the Urban Confluence project will be engraved into the stainless steel structure allowing visitors to see and touch the names that make this kind of collective effort possible. In this space you feel the bedrock of this endeavour, and glimpse the light - the sense of the dream - from above.

BREEZE OF INNOVATION Lithosphere



Foundation Event Space

Exhibition Possibilities

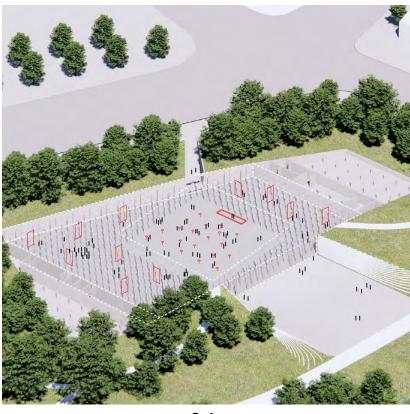






BREEZE OF INNOVATION Lithosphere


Gala


Crowd Around Performance

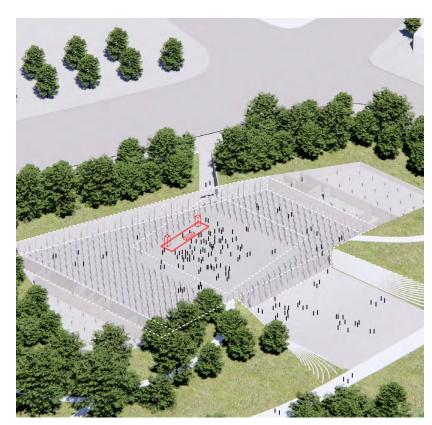

Concert

Performance Around Crowd

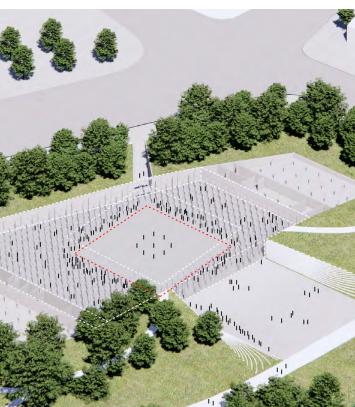

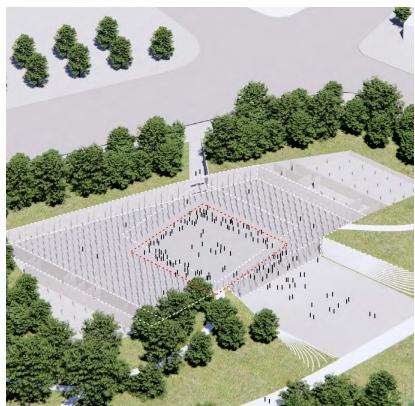

Foundation Event Space

This space is designed to be flexible and can be programmed in many different ways, to suit many different functions and styles of event, exhibition or installation.

BREEZE OF INNOVATION Biosphere





BREEZE OF INNOVATION Biosphere





Landscape

There is not one point at which the landscape ends and the building starts. The landscape is incorporated within the entire footprint of the structure creating a continuous and free public realm throughout the park and within the exterior areas of the Breeze project.

We are proposing modifications to the existing pathways on the western side of the river to create a more 'natural' parkland, where the focus is on the environment rather than the urban.

With this approach we preference meaningful public gathering spaces - free spaces - that are better able to accommodate special events.



BREEZE OF INNOVATION Biosphere



The Park

The park, as with the structure, is conceptualised as an extension of the existing ecological conditions of the park and riparian corridor. A series of zones radiate from the Guadalupe River and Los Gatos Creek. Each zone has a different landscape character and opportunities for different experiences.





1. Forest





BREEZE OF INNOVATION Biosphere

2. Native Ground Cover

Forested zones to the east and west boundary provide both a visual and acoustic buffer to the busy Guadalupe Parkway and N. Autumn St. Utilizing natives such as willow, rushes and wild radish to create lush & low-maintenance ground cover.

3. Lawn

4. Riparian Vegetation

Existing lawned areas to the west and east to be maintained. Opportunity for flexible public program including markets, pop-up events and festivals to be integrated with Breeze of Innovation Landmark.

High quality riparian vegetation on the western bank is supported and enhanced. Lower quality vegetation on the eastern bank presents opportunity for value-add via the enhancement of riparian habitat and the integration of user experience, offering moments to be immersed in nature.





2. Restorative Landscape






3. Confluence Plaza

4. Forest of Light

BREEZE OF INNOVATION Biosphere

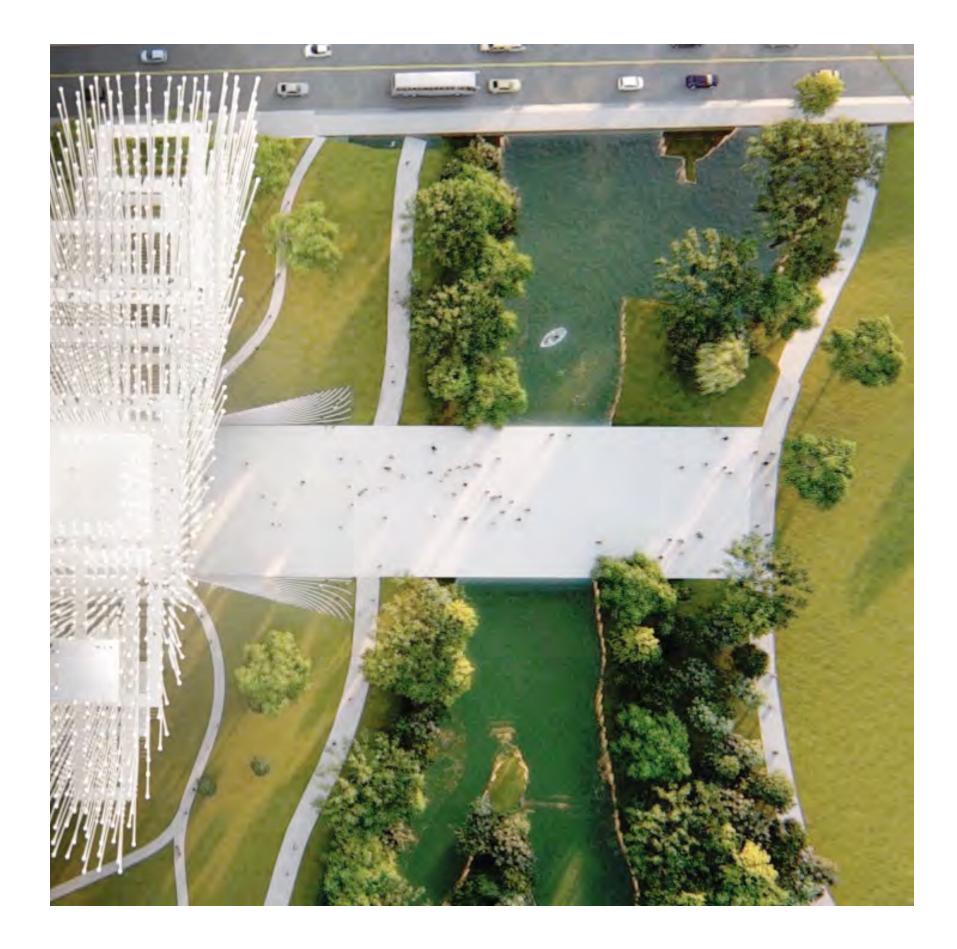

Connecting the two Parks


Additional to the Urban Confluence Project, we propose that a connection across the Guadalupe river may be developed by the City of San Jose. A bridge across the river would realise an opportunity to connect the Breeze landmark structure directly to the urban confluence of the Guadalupe River and Los Gatos Creek. This gesture puts the rivers, and the nature that co-exists with the city at the forefront of the experience of the landmark and connects the entire park into one continuous pedestrian zone.

S


The East and West sides of Arena Green are currently separate and only accessible via the small pedestrian sidewalks adjacent to the busy W Santa Clara St and W St John St.



BREEZE OF INNOVATION Biosphere

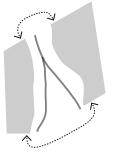


Separated Parks

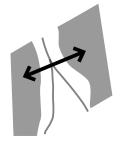


Unified Park

Creating a connection between these two sides will create a continuous pedestrian landscape and enhance the usability of the park as a whole.

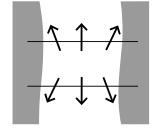


Enhanced Experience of River

The crossing provides the opportunity for more meaningful interaction and dialogue with the riparian corridor and waterway, to build public awareness and education of the nature that co-existing with the city.

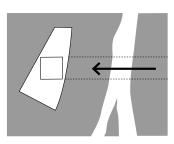

Enhanced Experience of Landmark


A connection in this location, leading directly to the landmark structure creates a 'ceremonial' avenue to the landmark structure which celebrates the ecological corridor and raises it to equal standing with the structure itself.

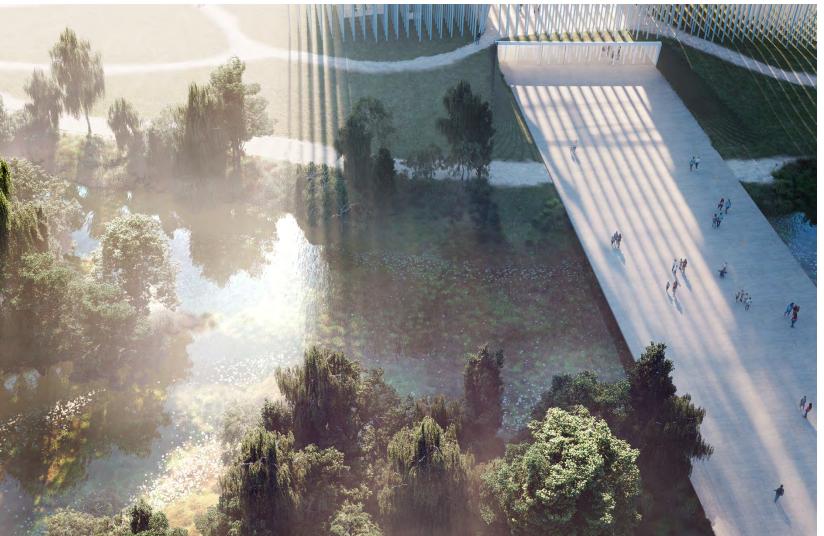

BREEZE OF INNOVATION Atmosphere



Tower of Light Event Space

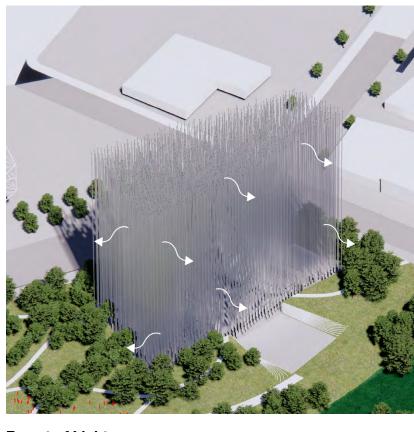




BREEZE OF INNOVATION Atmosphere

Forest of Light

1000 stainless steel rods move with the breeze and make visible the energy moving through our environment - a human-made structure given life by natural systems.


The satin reflective finish of the rods reflects the ambient light amplifying the changing mood of the sky throughout the day and across the seasons.

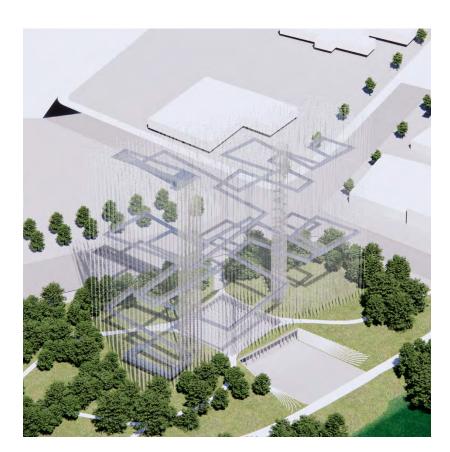


Forest Pathway

Visitors are invited to experience this change in atmosphere from afar and up close on one of the many ramped pathways which rise through the structure to the observation platform at the top of the structure.

These pathways are open to the air, minimizing the barriers between the visitor and the environment as you travel up through the structure.

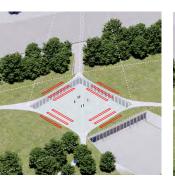


Central

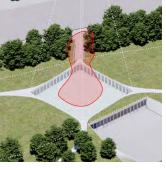

Singular



Confetti

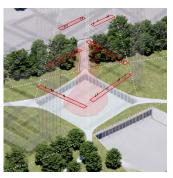

Above

The Tower of Light void created in memory of the San Jose Electric Light Tower is a space open to the elements and free for public use day and night. As an exhibition space it is able to accommodate a huge variety of events thanks to the volume and height of the space, and the relatively neutral backdrop of the stainless steel rods. The pathways which access the space can accommodate vehicle traffic for ease of event set-up. The ability to access the space from any direction makes events held here feel truly public and welcoming to all visitors.

Tower of Light Event Space

BREEZE OF INNOVATION Atmosphere









Canvas for Light

Curated Temporary Light Projection

BREEZE OF INNOVATION Atmosphere




Events in the Park

The presence of the atmosphere is always tangible, events take place under the back-drop of the breeze structure, gently swaying as the wind passes through.

For every Season


The structure is always reflecting the mood of the current weather and season, shifting and changing in character as the year goes by. The specialised lighting, powered by people, can be used to accent the colour of the structure for any event or occasion.

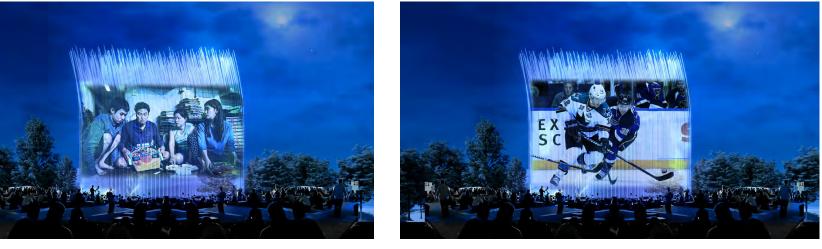

A Screen for Moving Image

The high density of the structural rods provides a surface for projecting light and images for special events or installation.



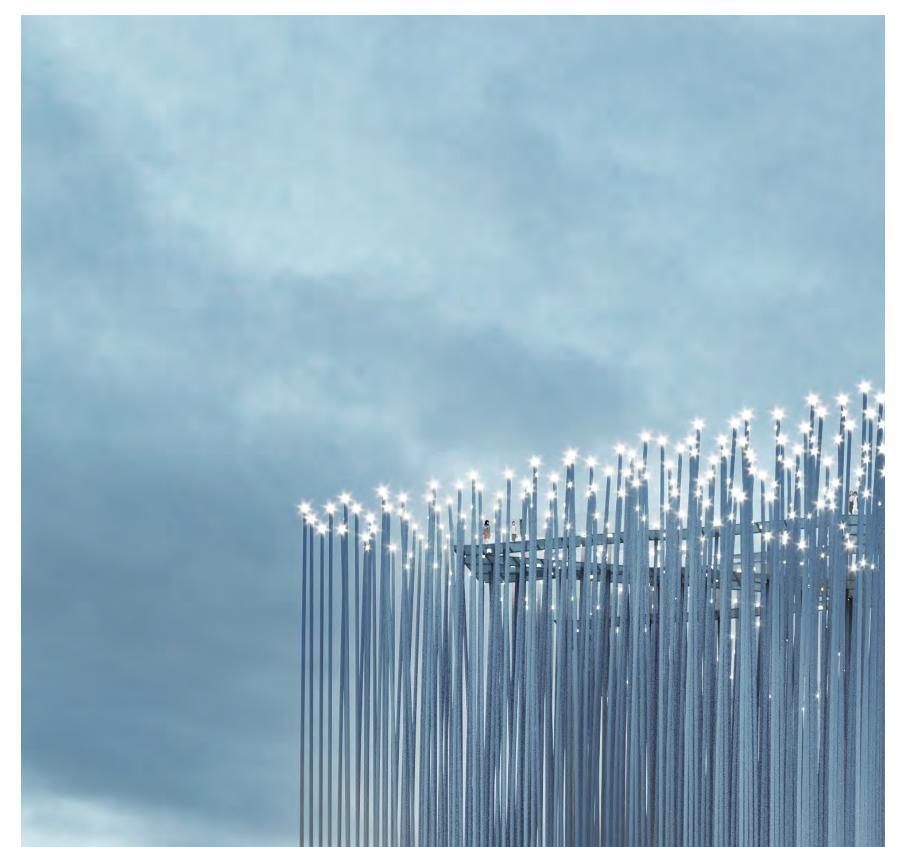

Urban Confluence Silicon Valley

66


BREEZE OF INNOVATION DRAWINGS

SMAR Architecture Studio MBH Architects Magnusson Klemencic HOK BKF Engeo niteo tbd consultants

JAN 18, 2021




ATE REV DESCRIPTION 5.01.2021 0 FOR REVIEW	PROJECT: SCHAMETIC DESIGN BREEZE OF INNOVATION URBAN COMFLUENCE SILICON VALLEY SAN JOSE, CALIFORNIA	CLIENT: SAN JOSE LIGHT TOWER CORPORATION	ARCHITECT: SMAR ARCHITECTURE STUDIO with: MBH Architects _ hok _ Megnussen Klemencic Accociates _ Niteo _ BKF _ Engeo _ tbd consultants	SHEET TITLE: SITE PLAN SCALE: 1:1500	SCHEMATIC DESIGN DRAWING NO: A-050
Key 1. Forest 2. Native No-mow Ground-cover 3. Lawn 4. Riparian Corridor 5. Confluence Plaza 6. Bridge to Future Design					\bigcirc
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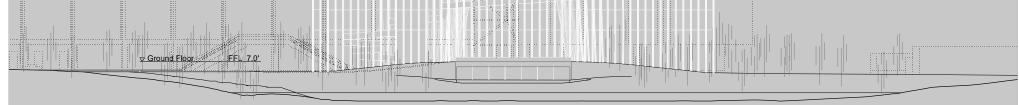


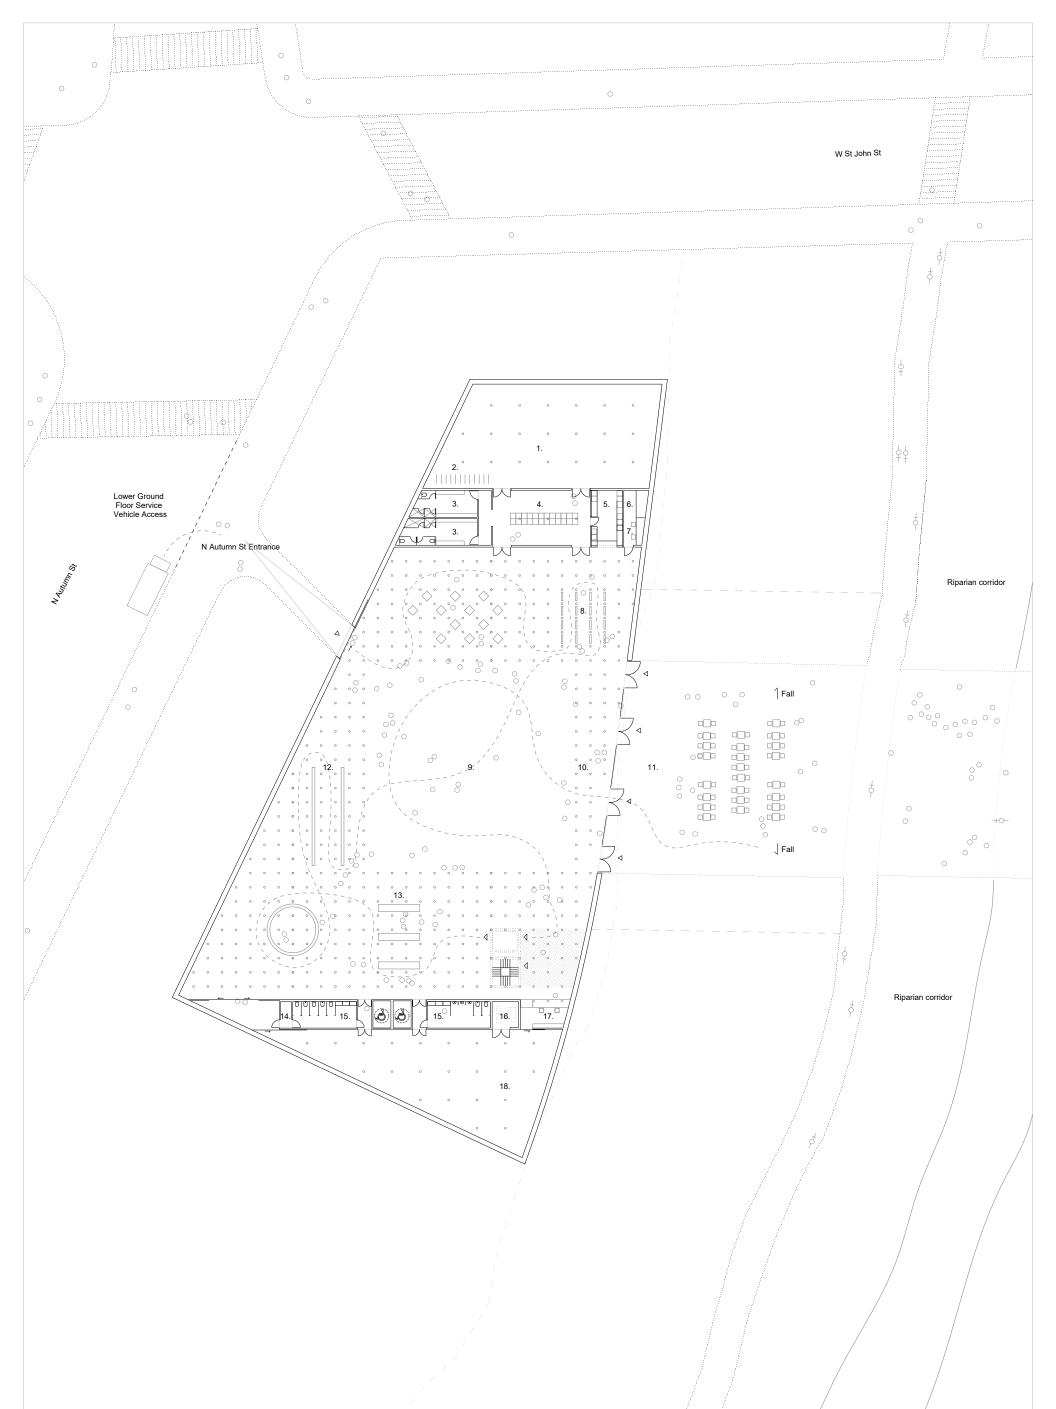2. 3. 4.	Plant & Storage Staff Bicycle Storage Staff WCs & Changing Rooms Staff Room / Green Room Staff Kitchen	640	sqft sqft	 IT Security Forest Exhibition Space Void Exhibition Space Confluence Entry 	75 sqft 65 sqft 3650 sqft 5450 sqft 920 sqft		whibition Space W whibition Space S B Room		 Elevator Machine Room Infomation Desk Storage 	80 sqft 155 sqft 2609 sqft			Ő
DATE 15.01.2021	REV DESCRIPTION 0 FOR REVIEW				CLIENT: SAN JOSE LIGHT TOWER CORPORATION	١		HITECTURE STUDIO) mencic Accociates _ Nileo _ BKF _ Engeo _ tbd cons	ultants	SHEET TITLE: LOWER GROUND FLOOR PLAN SCALE: 1:400 FL = -7.5'	SCHEMATIC DESIGN	A-100








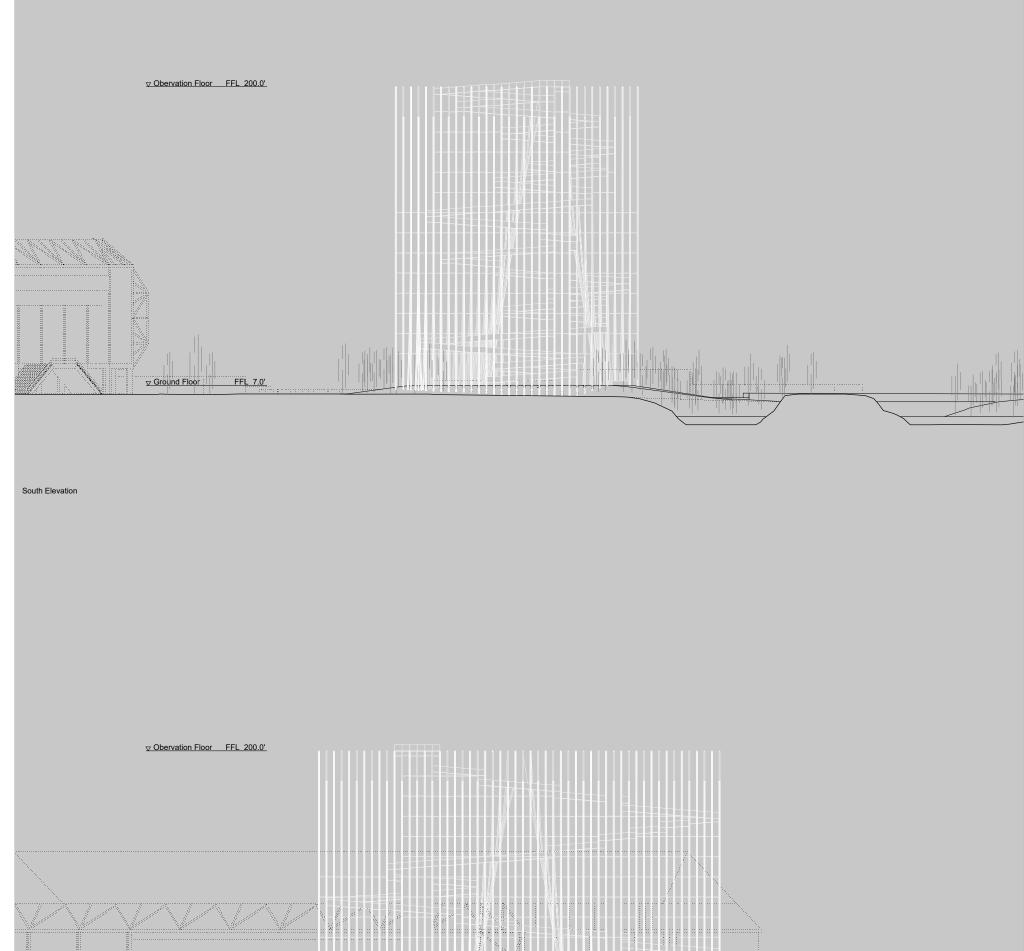



East Elevation


DATE REV DESCRIPTION 15.01.2021 0 FOR REVIEW	PROJECT: SCHAMETIC DESIGN BREEZE OF INNOVATION URBAN CONFLUENCE SILICON VALLEY SAN JOSE, CALIFORNIA	CLIENT: SAN JOSE LIGHT TOWER CORPORATION	ARCHITECT: SMAR ARCHITECTURE STUDIO with: MBH Architects _ hok _ Megnussen Klemencic Accociates _ Niteo _ BKF _ Engeo _ tbd consultants	SHEET TITLE: SOUTH & EAST ELEVATIONS SCALE: 1.750	SCHEMATIC DESIGN	A-150

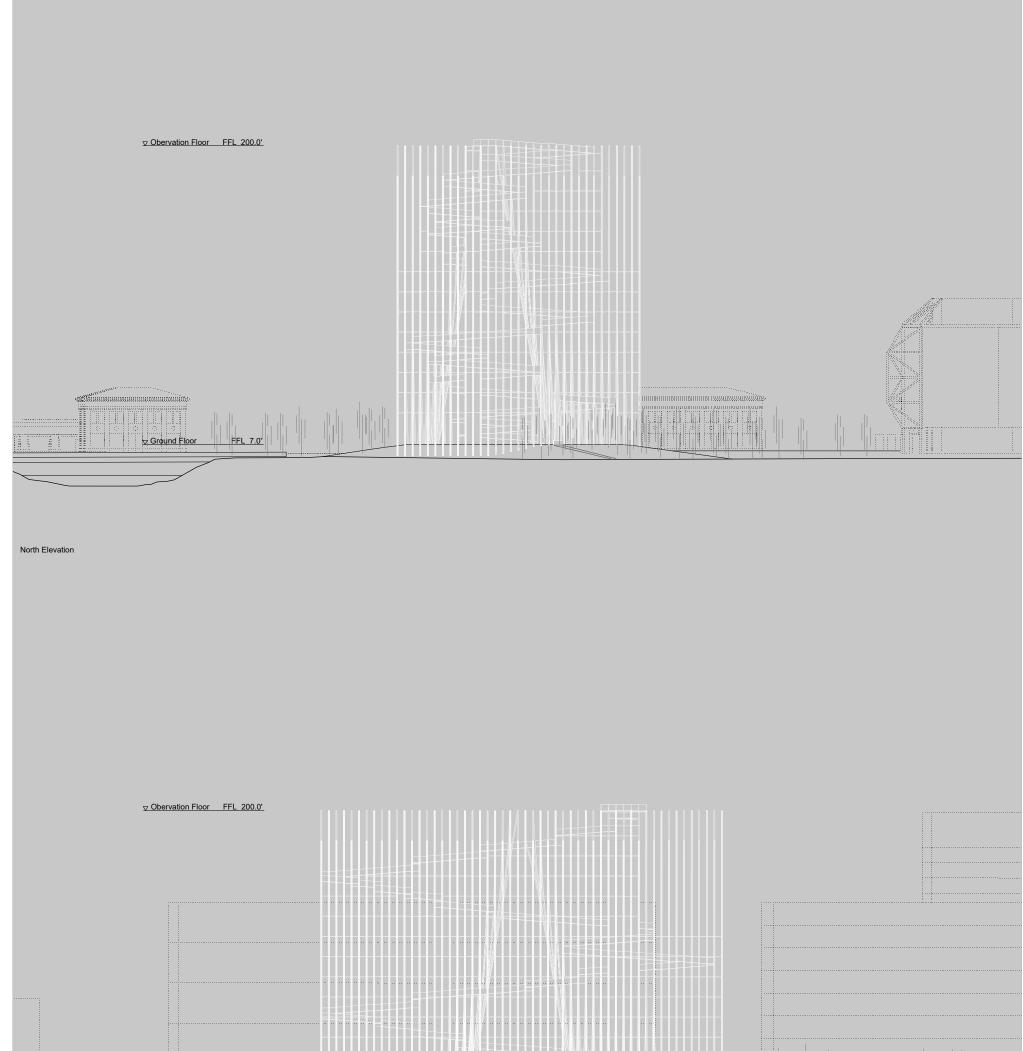


	<u>⊽ Grou</u>	nd Floor FFL 7.0'						
West Elevatio	n							
DATE REV DE	SCRIPTION							
	SCRIPTION R REVIEW	PROJECT: SCHAMETIC DESIGN BREEZE OF INNOVATION URBAN CONFLUENCE SILICON VALLEY SAN JOSE, CALIFORNIA	CLIENT: SAN JOSE LIGHT TOWER CORPORATION	ARCHITECT: SMAR ARCHITECTURE STUDIO with: MBH Architects _ hok _ Megnussen Klemencic Accociates _ Niteo _ BKF _ Eng	geo _ tbd consultants	SHEET TITLE: NORTH & WEST ELEVATIONS SCALE: 1:750	SCHEMATIC DESIGN	A-151

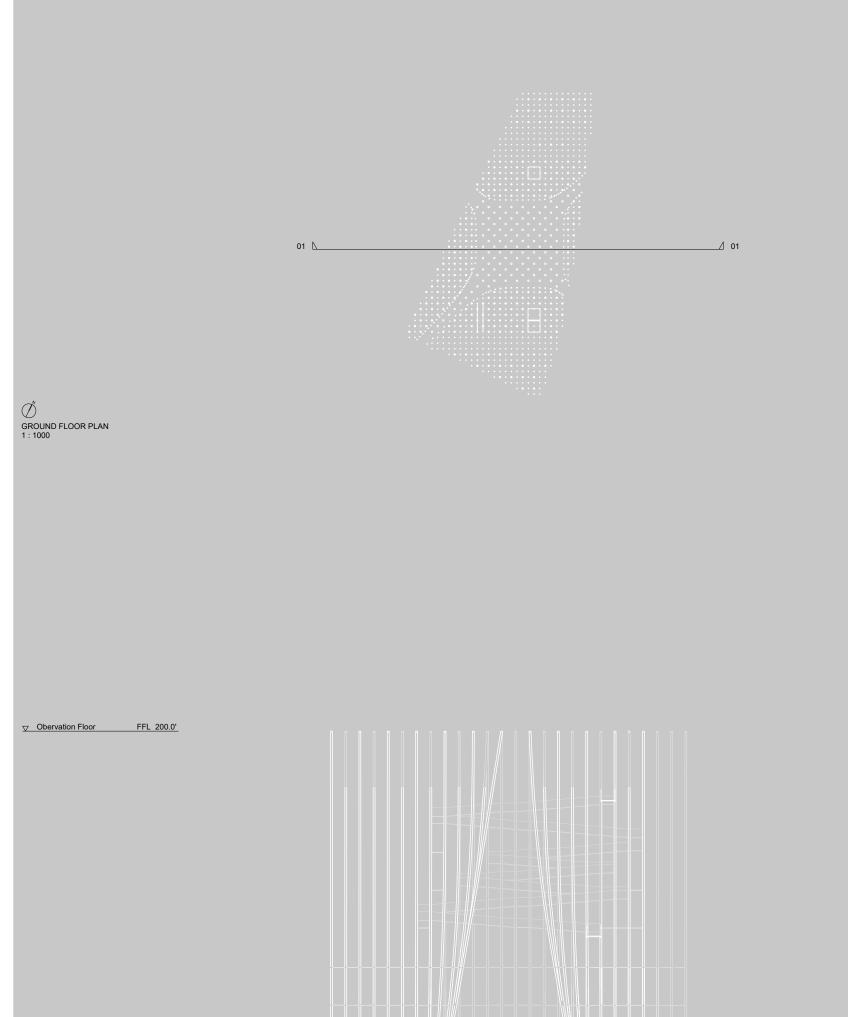

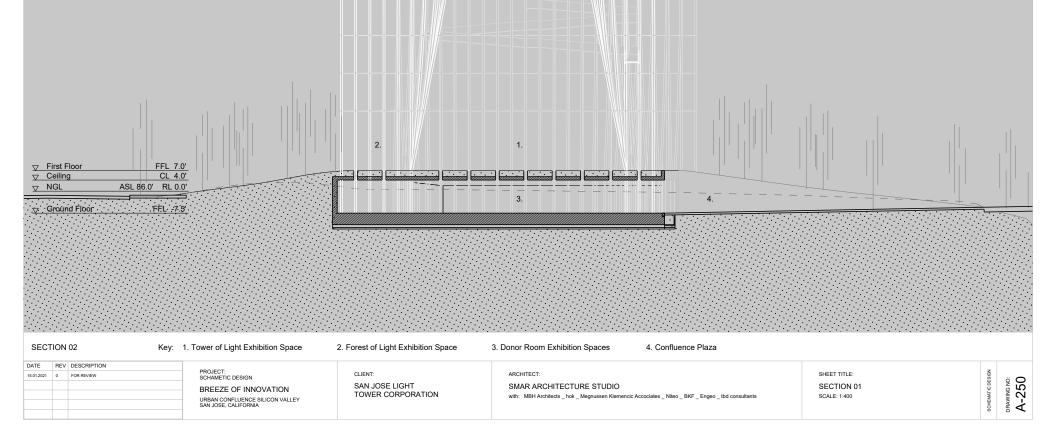

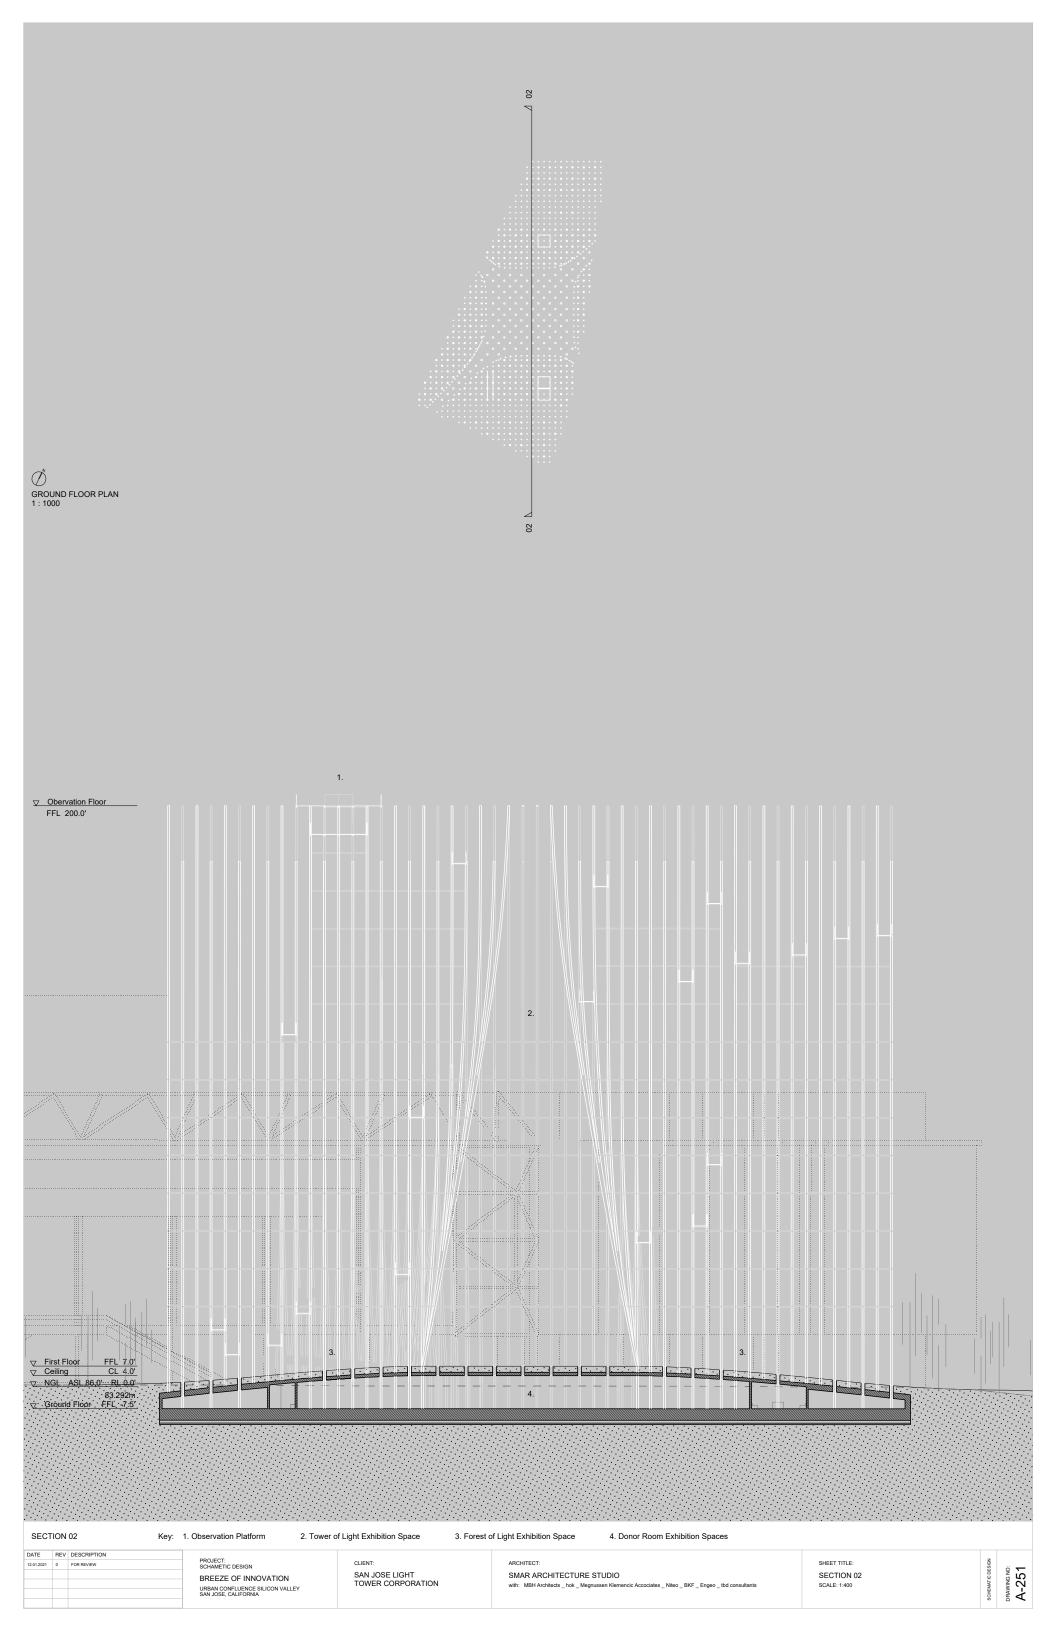

			Top of Rods RL 200.0' Image: state
		b.	 Continuous stainless steel handrail fixed to balustrade substructure at 2'10" via concealed connection Woven stainless steel mesh balustrade to 5' above floor surface Non-slip surface and proprietary energy generating paving system on 2" SPS floor system with, fixed on site via concealed bolted connection to stub welded to vertical rod 4" stainless steel bracing tube welded to vertical rod. Connects to adjacent
	2.		 Structural low-iron glass handrail Structural low-iron glass handrail 10" Crushed white gravel, on geotextile membrane, on 4" structural drainage layer, on waterproof membrane Concrete soffit 16" diameter tubular skylight around stainless steel rod
5.	4.		 Low-iron glass facade Stainless steel rod, satin finish, with engraved donor names 4" Polished concrete screed, over 18" gravel, over 4' concrete raft slab, over 12" setting out slab
			 13. 6" Slab on grade on 18" engineered fill *. Designed extent of rod sway shown dashed
	-6.		Upper Ground FFL 7.0

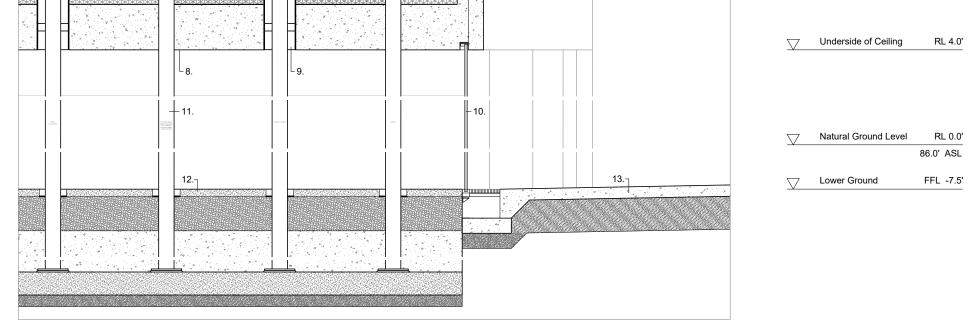

DATE REV DESCRIPTION 12.01.2021 0 FOR REVIEW	PROJECT: SCHAMETIC DESIGN BREEZE OF INNOVATION URBAN CONFLUENCE SILICON VALLEY SAN JOSE, CALIFORNIA	CLIENT: SAN JOSE LIGHT TOWER CORPORATION	ARCHITECT: SMAR ARCHITECTURE STUDIO with: MBH Architects _ hok _ Megnussen Klemencic Accociates _ Nileo _ BKF _ Engeo _ tbd consultants	SHEET TITLE: CONSTRUCTION SECTION SCALE: 1:50	SCHEMATIC DESIGN	DRAWING NO:
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